# WISCONSIN CITY OF MINERAL POINT IOWA COUNTY, WI CONTRACTOR SHOULD VERIFY LOCATIONS W/ THE UTILITY 00 00



**PROJECT LOCATION MAP** SCALE: N.T.S.

## PROPOSED 2020 INFRASTRUCTURE IMPROVEMENTS - PINE STREET

## **OWNER: CITY OF MINERAL POINT**

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## PROJECT INFORMATION:

CITY ADMINISTRATOR MS. ERIN HIRN CITY OF MINERAL POINT 137 HIGH STREET, SUITE 1 MINERAL POINT, WI 53565

#### TELEPHONE UTILITY:

MR. JERRY MOORE 100 COMMUNICATIONS DRIVE SUN PRAIRIE, WI 53590

#### STREETS AND STORM SEWERS:

CITY OF MINERAL POINT MR. TODD DONEY

#### CABLE TELEVISION UTILITY:

#### WATER AND SANITARY SEWER UTILITIES:

CITY OF MINERAL POINT 137 HIGH STREET, SUITE 1 MINERAL POINT, WI 53565 OFFICE: (608) 987-3442

PHOVE: (563) 542-9005

MR. MARK DIGMAN, P.E. DELTA 3 ENGINEERING, INC.

## TELEPHONE: (608) 348-5355

PROPOSED 2020 INFRASTRUCTURE IMPROVEMENTS - PINE STREET

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PROJECT NUMBER	D20-001	
SHEET SCALE	NOT TO SCALE	
DRAWN BY	C.COYIER	
DATE ISSUED	APRIL 27, 2020	
SHEET DESC.	TITLE SHEET & PROJECT	

G000

SHEET NUMBER # 01 of 15

137 HIGH STREET, SUITE 1

CHARTER COMMUNICATIONS

#### ELECTRICAL & NATURAL GAS UTILITIES:

ALLIANT ENERGY MR. PATRICK MUELLER

EX. U.GRD FIBER OPTIC UTILITY

EX. OVERHEAD ELECTRIC

EX. RAILROAD TRACKS

EX. DRAINAGE SWALE

EX. FENCE

--- 99 --- FX CONTOUR

--- PROP. SANITARY SEWER LATERAL XXXXX PROP. TYPE "X" CURB & GUTTER PROP. <6" SANITARY SEWER MAIN PROP. REVERSE-PITCH CURB & GUTTER - - PROP. 6" SANITARY SEWER MAIN PROP. 8" SANITARY SEWER MAIN PROP. 4" CONCRETE SIDEWALK — — PROP. 10" SANITARY SEWER MAIN — · · – · · — PROP. 12" SANITARY SEWER MAIN PROP. 6" CONCRETE PAVEMENT ---- PROP. 15" SANITARY SEWER MAIN PROP. 18" SANITARY SEWER MAIN PROP. FLOW DIRECTION PROP. WATER SERVICE PROP. <4" WATER MAIN PROP. 4" WATER MAIN - - PROP. 6" WATER MAIN — - — PROP. 8" WATER MAIN ---- PROP. 10" WATER MAIN --- PROP. 12" WATER MAIN ----- PROP. 15" WATER MAIN PROP. <12" STORM SEWER PROP. 12" STORM SEWER ---- PROP. 15" STORM SEWER --- PROP. 18" STORM SEWER ----- PROP. 24" STORM SEWER — — PROP. 30" STORM SEWER ---- PROP. 36" STORM SEWER ----- PROP. 48" STORM SEWER PROP. CURB AND GUTTER PROP. CURB BACK OPENING GAS—— PROP. U.GRD GAS UTILITY PROP. U.GRD ELECTRIC UTILITY PROP. U.GRD CABLE TV UTILITY PROP. U.GRD TELEPHONE UTILITY PROP. U.GRD FIBER OPTIC UTILITY OHE PROP. OVERHEAD ELECTRIC PROP. CROSSING OF N. GAS UTILITY PROP. UTILITY POLE PROP. LIGHT POLE PROP. FENCE ———— TEMPORARY EASEMENT ----- CONSTRUCTION EASEMENT

ESTIMATED DISTURBANCE LIMITS PROP. CONTOUR ─── ← PROP. DRAINAGE SWALE PROP. SILT FENCE PROP. EROSION CONTROL SEDIMENT LOG PROP. PAVEMENT MARKING

PAINTED TRAFFIC ARROW

ADA PARKING DESIGNATION

10 PARKING STALL COUNT 5'R + 0+00

RADIUS POINT/SIZE STA. ON CENTERLINE

PROP. HANDICAP RAMP WITH DETECTABLE WARNING FIELD

SOIL BORING LOCATION

PROP. 4' DIA. SANITARY MANHOLE

PROP. 5' DIA. SANITARY MANHOLE

PROP. MANHOLE CHIMNEY REHABILITATION / TOP ADJUSTMENT

PROP. SANITARY LIFT STATION

## KEY NOTES 100 .

100 PROPOSED SILT FENCE FOR EROSION CONTROL

101 PROPOSED SEDIMENT LOG FOR EROSION CONTROL

102 PROPOSED TRACKING PAD FOR EROSION CONTROL.

202 REPLACE EXISTING SANITARY SEWER LATERAL.

204 CONNECTION TO EXISTING SANITARY SEWER

203 RECONNECT EXISTING SANITARY SEWER LATERAL.

206 REHABILITATE SANITARY MANHOLE; SEE TABLE 'B'.

208 ABANDON AND CAP EXISTING SANITARY SEWER.

302 REPLACE EXISTING WATER SERVICE WITH 1" WATER

306 EXISTING HYDRANT TO BE REMOVED AND SALVAGED TO

307 REMOVE EXISTING WATER MAIN VALVE BOX/STRUCTURE.

LOCATION/ACTIVITY AND REPLACE ACCORDING TO ENGINEER.

COMPLETE CONSTRUCTION. ALL CLEARING TO BE VERIFIED

504 REMOVE AND REINSTALL/REPLACE EXISTING LANDSCAPING,

402 CONNECTION TO EXISTING STORM SEWER PIPE/STRUCTURE.

304 DIRECTIONAL DRILL PROPOSED WATER SERVICE.

209 ABANDON EXISTING SANITARY SEWER LATERAL

205 REMOVE EXISTING SANITARY SEWER PIPE/STRUCTURE.

210 CONTRACTOR TO FIELD VERIFY SANITARY SEWER LATERAL

LOCATION/ACTIVITY AND REPLACE ACCORDING TO ENGINEER.

103 RE-GRADE YARD/DITCH LINE (MIN. SLOPE 1.0%).

104 PROPOSED EROSION MAT CLASS I, TYPE 'B'.

105 INSTALL TYPE 'D' INLET PROTECTION.

106 PROPOSED MAIL BOX RELOCATION. 107 ITEM TO REMAIN.

PIPE/STRUCTURE.

207 SANITARY SEWER SPOT REPAIR.

300 PROPOSED WATER MAIN [SIZE].

303 RECONNECT EXISTING WATER SERVICE.

305 CONNECTION TO EXISTING WATER MAIN.

308 ADJUST EXISTING WATER MAIN VALVE BOX.

310 ABANDON EXISTING WATER SERVICE.

400 PROPOSED STORM SEWER [SIZE].

309 ABANDON, DRAIN, & CAP EXISTING WATER MAIN.

311 CONTRACTOR TO FIELD VERIFY WATER SERVICE

401 CONNECT EXISTING ROOF DRAIN TO CURB OPENING

403 REMOVE EXISTING STORM SEWER PIPE/STRUCTURE.

500 TREE & STUMP TO BE REMOVED (LESS THEN 12")

501 TREE & STUMP TO BE REMOVED (12" & GREATER)

503 CLEAR AND GRUB BRUSH LINE AS NECESSARY TO

FENCE, RETAINING WALL, ETC. (IF NECESSARY). 505 REMOVE EXISTING LANDSCAPING, FENCE, RETAINING WALL,

507 POLE TO BE RELOCATED BY UTILITY COMPANY.

508 GUY WIRE TO BE RELOCATED BY UTILITY COMPANY.

509 PEDESTAL TO BE RELOCATED BY UTILITY COMPANY.

511 POTENTIAL UTILITY CONFLICT - VERIFY WITH UTILITY

510 UTILITY CONFLICT - TO BE RELOCATED/ADJUSTED BY UTILITY

506 POLE/PEDESTAL TO BE SECURED BY UTILITY COMPANY

404 ABANDON & CAP EXISTING STORM SEWER.

405 ADJUST EXISTING STORM STRUCTURE.

502 SHRUB TO BE REMOVED.

BY PROJECT ENGINEER.

DURING CONSTRUCTION

512 CAUTION! - UTILITY CROSSING.

605 PROVIDE TYPE 'X' CURB.

607 PROVIDE CURB TAPER.

600 REMOVE EXISTING CURB & GUTTER.

604 MATCH TO EXISTING CURB & GUTTER.

609 PROPOSED 4" CONCRETE SIDEWALK.

611 PROPOSED 6" CONCRETE PAVEMENT.

612 PROPOSED 8" CONCRETE PAVEMENT

614 PROPOSED 2' GRAVEL SHOULDER.

617 REMOVE & REPLACE GRAVEL DRIVEWAY.

615 REGRADE EXISTING GRAVEL.

DRIVEWAY/APRON.

616 PROPOSED GRAVEL DRIVEWAY.

601 PROPOSED 24" CONCRETE CURB & GUTTER

602 PROPOSED 30" CONCRETE CURB & GUTTER.

603 PROPOSED 36" CONCRETE CURB & GUTTER.

606 PROVIDE REVERSE-PITCH CURB & GUTTER.

608 REMOVE ASPHALT/CONCRETE/WALL/STEPS.

610 PROPOSED 6" CONCRETE SIDEWALK/DRIVEWAY.

613 PROPOSED CONCRETE STEPS. STEP RISE HEIGHT AND STEP

CONTRACTOR SHALL CONFIRM REQUIRED NUMBER OF

618 REMOVE GRAVEL DRIVEWAY & REPLACE WITH BITUMINOUS

STEPS WITH PROJECT ENGINEER PRIOR TO INSTALL.

TREAD DEPTH SHALL MEET APPLICABLE BUILDING CODES.

COMPANY

COMPANY

301 NEW WATER SERVICE [SIZE].

OWNER

108 CONTRACTOR TO REMOVE ITEM. 200 PROPOSED SANITARY SEWER [SIZE]. PROP. 8" CONCRETE PAVEMENT 201 NEW SANITARY SEWER LATERAL (SIZE).

PROP. GRAVEL SHOULDER / DRIVEWAY

PROP. HOT MIX ASPHALT PAVEMENT (DRIVEWAY)

EROSION MATTING (MILD SLOPES) EROSION MATTING (STEEP SLOPES)

PROP. REGRADING AND LANDSCAPING

PROP. RIP-RAP

PROP. STORM STRUCTURES - PROFILE

PROP. STORM PIPE(RCP) - PROFILE

PROP. STORM PIPE(CMP OR HDPE) - PROFILE

PROP. SANITARY STRUCTURE - PROFILE PROP. WATER MAIN PIPE - PROFILE PROP. CLAY LINER - PROFILE

PROP. SANITARY SEWER FORCE MAIN - PROFILE

PROP. SPOT REPAIR - PROFILE / PLAN VIEW

PROP. CASING PIPE - PROFILE

PROP. CLEARING AND GRUBBING

PROP. BUILDING REMOVAL

PROP. SIDEWALK REMOVAL

PROP. PRESSURE-REDUCING VALVE STATION

• PROP. FIRE HYDRANT Ø PROP. WATER SERVICE **6** 

PROP. WATER SERVICE WITH VALVE BOX SLEEVE

PROP. WATER VALVE PROP. WATER BEND - HORIZONTAL

PROP. WATER BEND - VERTICAL PROP. WATER BEND <5°

野 PROP. WATER TEE PROP. WATER CROSS

PROP. WATER REDUCER PROP. MJ PLUG

PROP. 4' DIA. STORM MANHOLE

PROP. 5' DIA. STORM MANHOLE

PROP. INLET

PROP. 4' DIA. INLET

PROP. 6' DIA. INLET

PROP. 4' DIA. CATCH BASIN- W/ 2'X3' CASTING

PROP. 5' DIA. CATCH BASIN- W/ 2'X3' CASTING

PROP. 6' DIA. CATCH BASIN- W/ 2'X3' CASTING

PROP. 4'X6' CATCH BASIN W/2'X3' CASTING

PROP. CURB OPENING CASTING

PROP. 2'X3' CATCH BASIN PROP. ADJUSTED CATCH BASIN TOP

PROP. WISDOT TYPE 8 INLET PROP. WISDOT TYPE 9 INLET

PROP. CMP ENDWALL PROP. RCP ENDWALL

TRAFFIC CONTROL NOTE: ALL CONTRACTORS MUST CONFORM TO THE MANUAL OF UNIFORM TRAFFIC CONTROL DEVICES (MUTCD) AND THE REQUIREMENTS OF THE WISCONSIN DEPARTMENT OF TRANSPORTATION. ONE LANE OF TRAFFIC MUST REMAIN FOR EMERGENCY VEHICLE ACCESS.

STREET SIGN NOTE

CONTRACTOR WILL BE RESPONSIBLE FOR REMOVING, STORING, AND RESETTING ALL PERMANENT SIGNS. CONTRACTOR IS RESPONSIBLE FOR PROTECTING ALL EXISTING SIGNS UNTIL REMOVED. CONTRACTOR IS RESPONSIBLE FOR ANY AND ALL TEMPORARY SIGNS THAT MAY BE REQUIRED

TRAFFIC SIGN NOTE:

CONTRACTOR TO PROVIDE TEMPORARY TRAFFIC SIGNS FOR ANY TRAFFIC SIGNS DISTURBED DURING CONSTRUCTION. ALL DISTURBED TRAFFIC SIGNS MUST BE REPLACED AND INSTALLED AS PER LOCAL REGULATIONS AT THE COMPLETION OF THE PROJECT.

**EROSION CONTROL NOTE:** CONTRACTOR TO INSTALL BACKFILL MATERIAL INTO THE EXCAVATED TRENCH AS SOON AS POSSIBLE TO IMPLEMENT EROSION CONTROL.

PROPERTY LINE AND RIGHT-OF-WAY NOTE. ALL RIGHT-OF-WAYS AND PROPERTY LINES SHOWN ARE APPROXIMATE AND FOR ILLUSTRATIVE PURPOSES ONLY. A PROPERTY SURVEY PERFORMED BY A PROFESSIONAL LAND SURVEYOR SHOULD BE COMPLETED TO DETERMINE THE ACTUAL PROPERTY LINE AND RIGHT-OF-WAY LOCATIONS.

MAILBOX RELOCATION NOTE: CONTRACTOR TO RELOCATE EXISTING MAIL BOXES DURING CONSTRUCTION (COORDINATE AND VERIFY WITH LOCAL POSTAL SERVICE ON LOCATION). RESET BEHIND CURB AND GUTTER OR SHOULDER ACCORDING TO THE REQUIREMENTS OF THE LOCAL POSTMASTER UPON COMPLETION OF STREET CONSTRUCTION.

TREE TRIMMING NOTE: CONTRACTOR TO PROPERLY TRIM ALL TREE BRANCHES, ROOTS, AND BUSHES DISTURBED DUE TO SANITARY SEWER, WATER SYSTEM, STORM SEWER, AND STREET CONSTRUCTION.

TREE REMOVAL NOTE:
CONTRACTOR TO CONTACT ENGINEER OR CITY OF MINERAL POINT FOR VERIFICATION PRIOR TO ANY TREE REMOVAL.

SAW CUT NOTE

CONTRACTOR TO PROVIDE FULL DEPTH SAW CUTS AND REPLACE PAVEMENT.

UTILITIES' NOTE:

THE LOCATIONS OF THE UNDERGROUND UTILITIES SHOWN ON THE PLAN HAVE BEEN OBTAINED BY FIELD CHECKS, A UTILITY LOCATE THROUGH DIGGER'S HOTLINE, AND SEARCHES OF AVAILABLE RECORDS. IT IS BELIEVED THAT THEY ARE ESSENTIALLY CORRECT, BUT THE SURVEYOR DOES NOT GUARANTEE THEIR ACCURACY OR COMPLETENESS. THE CONTRACTOR SHOULD VERIFY LOCATIONS W/ THE UTILITY COMPANIES AND CITY OF MINERAL POINT PRIOR TO STARTING ANY EXCAVATION.

619 REMOVE & REPLACE HMA PAVEMENT.

622 MATCH TO EXISTING EDGE PAVEMENT

630 PROPOSED BITUMINOUS WEDGE CURB.

621 PROPOSED HMA PAVEMENT.

628 SAW CUT PCC PAVEMENT.

629 SAW CUT HMA PAVEMENT.

620 REMOVE & REPLACE HMA PAVEMENT DRIVEWAY.

625 REMOVE & REPLACE 4" CONCRETE SIDEWALK.

623 PROPOSED RESIDENTIAL HMA PAVEMENT DRIVEWAY.

624 PROPOSED COMMERCIAL HMA PAVEMENT DRIVEWAY.

626 REMOVE & REPLACE 6" CONCRETE SIDEWALK/DRIVEWAY

627 PROPOSED HANDICAP RAMP WITH - D. WARN. FIELD [S.F].

NOTES:

SANITARY SEWER LATERAL NOTE: THE LOCATION OF EXISTING SANITARY SEWER LATERALS ARE APPROXIMATE. THE CONTRACTOR SHALL VERIFY THE LOCATION AND STATUS OF EACH SANITARY SEWER LATERAL ENCOUNTERED. ONLY ACTIVE SANITARY SEWER OPEN DURING AND AFTER ALL CONSTRUCTION ACTIVITIES LATERALS SHALL BE CONNECTED TO THE NEW SANITARY SEWER MAIN.

CASTING NOTE

ALL EXISTING MANHOLE CASTINGS AND STORM SEWER CASTINGS TO BE REMOVED AND/OR REPLACED SHALL BE SALVAGED TO THE **CITY OF MINERAL POINT**.

WATER SYSTEM NOTE.

CONTRACTOR TO SALVAGE EXISTING HYDRANTS TO BE REMOVED TO THE CITY OF MINERAL POINT. REMOVE EXISTING HYDRANTS TO A MINIMUM DEPTH OF 4'-0".

TRACER WIRE (12 GAUGE) TO BE INSTALLED WITH ALL POLYVINYL CHLORIDE (PVC) AND CLASS 52 DUCTILE IRON

WATER SERVICE NOTE: CONTRACTOR TO VERIFY STATUS AND LOCATION OF EACH WATER SERVICE ENCOUNTERED. CONTRACTOR TO REPLACE ACCORDING TO ENGINEER. ONLY ACTIVE WATER SERVICES SHALL BE CONNECTED TO THE NEW WATER

SITE RESTORATION NOTE.

CONTRACTOR WILL BE RESPONSIBLE FOR REPLACEMENT OF ALL DISTURBED PROJECT AREA COMPONENTS INCLUDING, BUT NOT LIMITED TO, EXISTING CONCRETE, BITUMINOUS PAVEMENT, GRAVEL, CULVERTS, WATER AND SANITARY SEWER SYSTEM COMPONENTS. STORM SEWER SYSTEM COMPONENTS, TREES, LAWN ORNAMENTS, FENCING, YARD LANDSCAPING, RETAINING WALLS. MAILBOXES, AND LANDSCAPE AREAS.

PROPERTY DAMAGES:

THE CONTRACTOR IS RESPONSIBLE FOR THE PRESERVATION OF ADJACENT PROPERTY AND FOR ANY DAMAGE TO THE SITE OR TO ADJACENT PROPERTY INCIDENTAL TO THE CONSTRUCTION ACTIVITIES. AFTER THE COMPLETION OF CONSTRUCTION, ANY AREAS ADJACENT TO THE CONSTRUCTION SITE DAMAGED BY THE CONTRACTOR DURING EXECUTION OF THE CONTRACT SHALL BE RESTORED TO MATCH THE PRECONSTRUCTION CONDITIONS.

RETAINING WALL NOTE:

CONTRACTOR WILL BRACE ALL EXISTING AND PROPOSED RETAINING WALLS DURING CONSTRUCTION AS NECESSARY TO PROTECT THEM FROM DAMAGE. NO HEAVY EQUIPMENT SHALL BE ALLOWED WITHIN 10 FEET OF EXISTING RETAINING WALLS UNLESS OTHERWISE APPROVED BY PROJECT ENGINEER.

> DISCIPLINE **DESIGNATION** REMOVAL GENERAL G CIVII **LANDSCAPE** AQUATIC AQ ARCHITECTURAL STRUCTURAL **ELECTRICAL** INSTRUMENTATION/CONTROLS **PROCESS** PLUMBING HVAC /MECHANICAL **DISCIPLINE DESIGNATORS**

DESIGNATION NOTES & SCHEDULES PI ANS **ELEVATIONS & DETAILS** CROSS-SECTIONS DIAGRAMS

DRAWING SHEET DESIGNATION



898 Jackson Street Dubuque, Iowa 52001 PHONE: (563) 542-9005 FOR QUESTIONS REGARDING THIS PROJECT, PLEASE CONTACT:

MR. MARK DIGMAN, P.E.

A DELTA 3

875 SOUTH CHESTNUT STREET PHONE: (608) 348-5355 PLATEVILLE, WISCONSIN 53818

PROFESSIONAL CML, MUNICIPAL, & STRUCTURAL ENGINEERING+ARGERING+ARGERING+LAND DEVELOPMENT+PLANNING & CAUD. S

DELTA 3 ENGINEERING INC TELEPHONE: (608) 348-5355

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**NERA**I N: PINE STREE POINT; 137 HK

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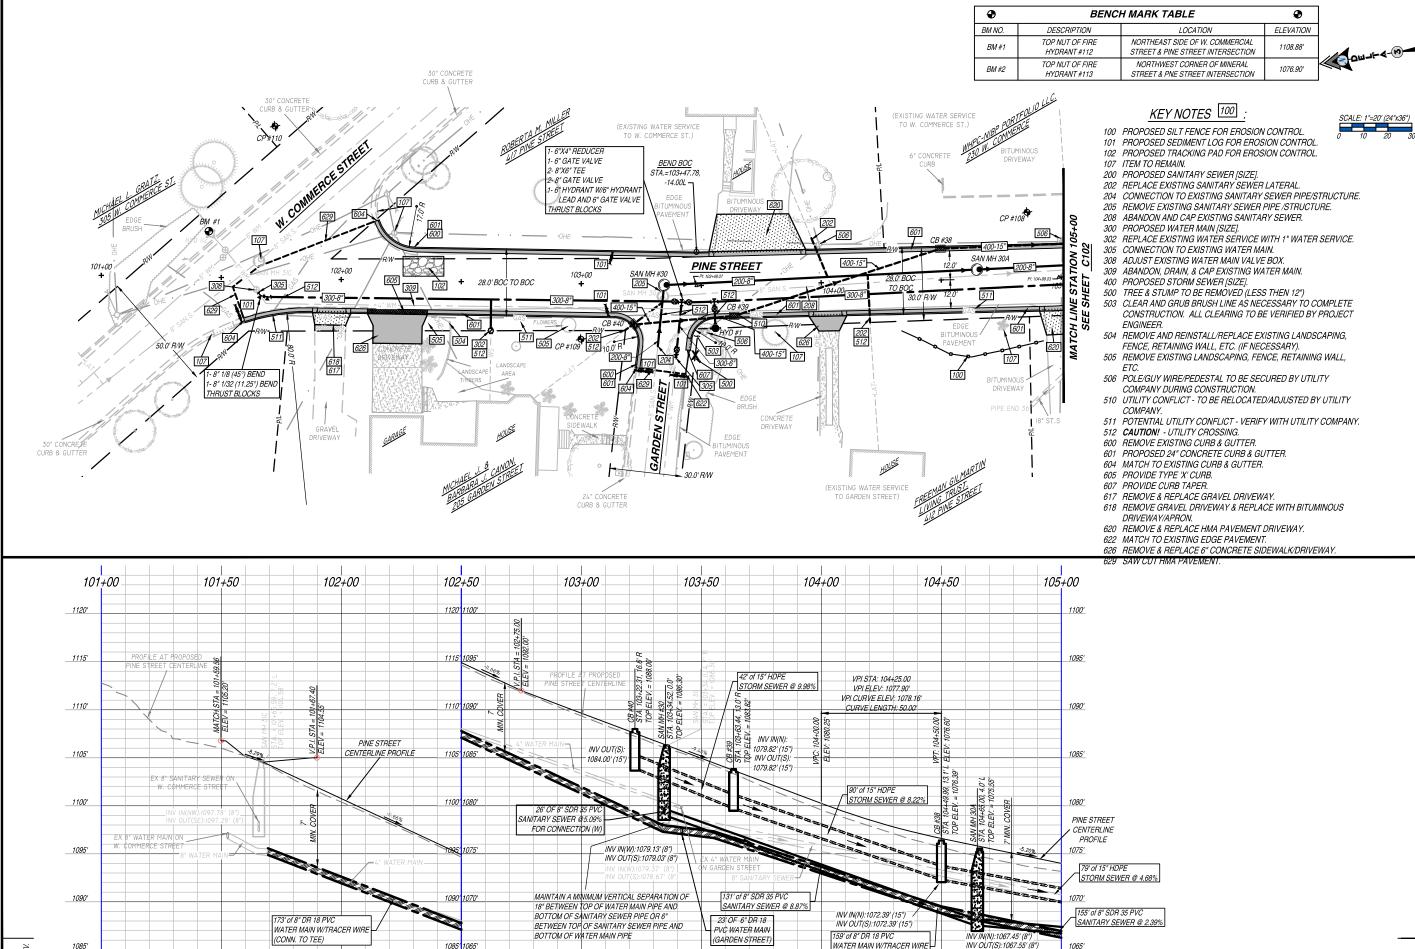
S-BUILT

D20-001 NOT TO SCALE DRAWN C.COYIER DATE ISSUED APRIL 27, 2020 LEGEND & SHEET DESC. GENERAL NOTES

SHEET TITLE:

G001

NUMBER # 02 of 15



1085'

DELTA 3 PHONE: (563) 542-9005 898 JACKSON STREET DUBUQUE, 10WA 52001

FOR QUESTIONS REGARDING THIS PROJECT, PLEASE CONTACT:

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PROPOSED 2020 INFRASTRUCTUR IMPROVEMENTS - PINE STREET

 $\mathbf{z}$ POINT, MINERAL

NO.	DATE	DESCRIPTION
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	-//	-,

FOR BID					
PROJECT NUMBER	D20-001				
SHEET SCALE	HORZ1" =20' VERT1" =5'				
DRAWN BY	C.COYIER				
DATE ISSUED	APRIL 27, 2020				
SHEET DESC.	PLAN & PROFILE - PINE STREET				


SHEET TITLE:

1065'

(TEE TO STA.105+00)

C101

NUMBER # 03 of 15

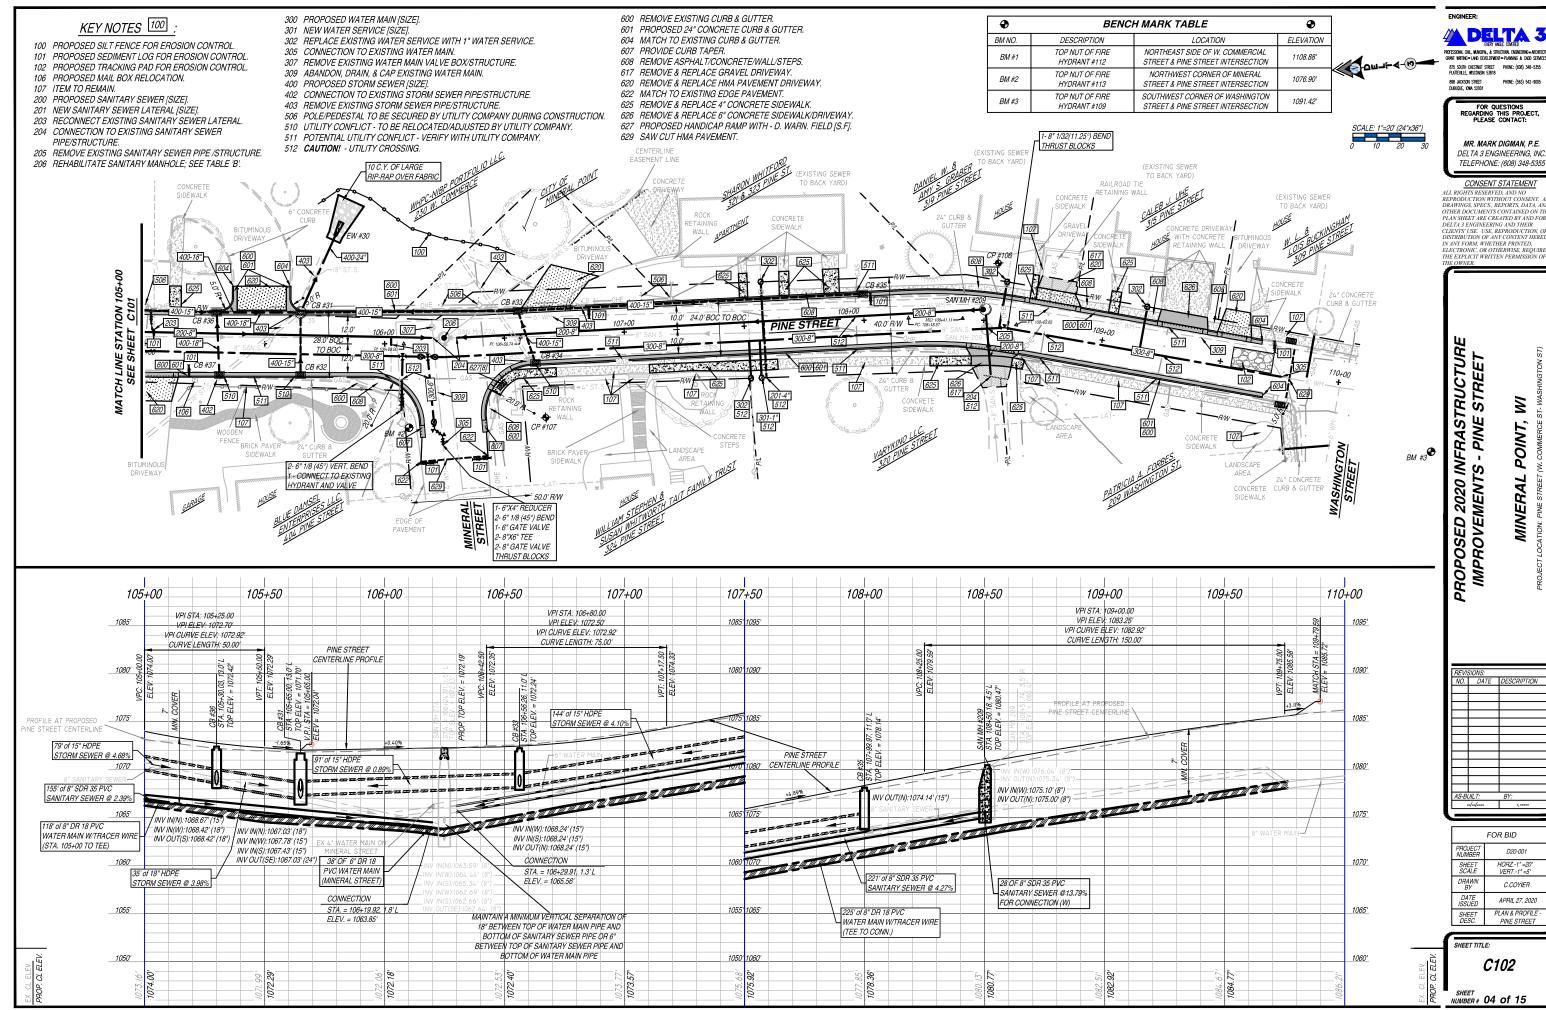

DELTA 3

CONSENT STATEMENT


APRIL 27, 2020 PLAN & PROFILE

•	BENCH MARK TABLE			
BM NO.	DESCRIPTION	LOCATION	ELEVATIO:	
BM #1	TOP NUT OF FIRE HYDRANT #112	NORTHEAST SIDE OF W. COMMERCIAL STREET & PINE STREET INTERSECTION	1108.88'	
BM #2	TOP NUT OF FIRE HYDRANT #113	NORTHWEST CORNER OF MINERAL STREET & PINE STREET INTERSECTION	1076.90'	
BM #3	TOP NUT OF FIRE HYDRANT #109	SOUTHWEST CORNER OF WASHINGTON STREET & PINE STREET INTERSECTION	1091.42'	








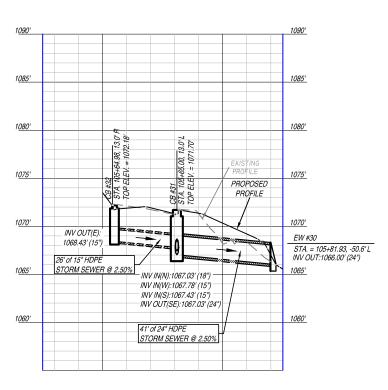

END WALL #30 TO CATCH BASIN #32

1<u>095</u>' 1095' 1<u>090'</u> 1090' 1<u>085'</u> 1085′ 1<u>080'</u> 1080' 1<u>075'</u> 1075' PROPOSED PROFILE PROFILE 1<u>070'</u> 1070' INV OUT(E): INV IN(S):1068.24' (15") INV OUT(N):1068.24' (15") 1070.02' (15") 23' of 15" HDPE 1<u>065'</u> 1065' STORM SEWER @ 7.79%

CATCH BASIN #33 TO CATCH BASIN #34

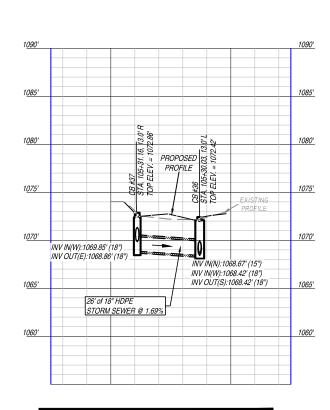

CATCH BASIN #36 TO CATCH BASIN #37

PROPOSED 2020 INFRASTRUCTURE IMPROVEMENTS - PINE STREET MINERAL POINT, WI LOCATION: PINE STREET (W. COMMERCE ST- WA MINERAL POINT; 137 HIGH STREET, SUITE 1, MINE

DELTA 3

898 JACKSON STREET PHONE: (563) 542–9006 DUBUQUE, 10WA 52001

FOR QUESTIONS REGARDING THIS PROJECT, PLEASE CONTACT:

MR. MARK DIGMAN, P.E. DELTA 3 ENGINEERING, INC. TELEPHONE: (608) 348-5355

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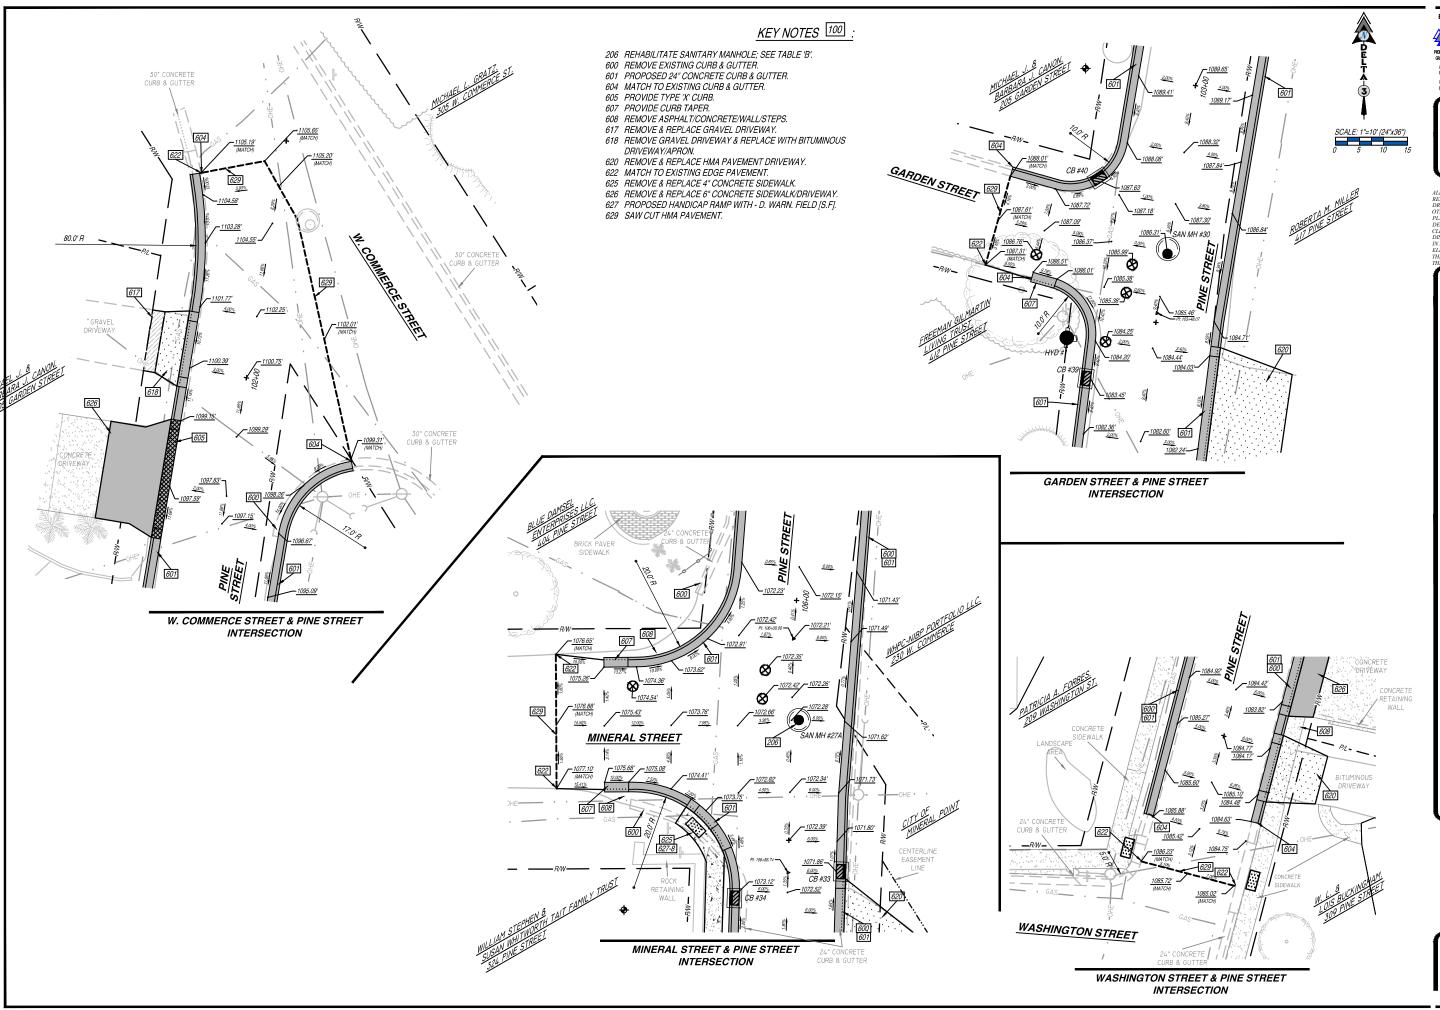
AS-BUILT: D20-001

PROJECT NUMBER SHEET SCALE HORZ.-1" =20' VERT.-1" =5' DRAWN BY C.COYIER DATE ISSUED APRIL 27, 2020 SHEET PROFILE - PINE STREE DESC. STORM CROSSINGS

SHEET TITLE:

C103

SHEET NUMBER # 05 of 15



DELTA 3 875 SOUTH CHESTNUT STREET PHONE: (608) 348-5355 PLATTEVILLE, WISCONSIN 53818 898 JACKSON STREET DUBUQUE, IOWA 52001

FOR QUESTIONS REGARDING THIS PROJECT, PLEASE CONTACT:

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MINERAL POINT,


PROPOSED 2020 INFRASTRUCTUR IMPROVEMENTS - PINE STREET


PROJECT NUMBER D20-001 SHEET SCALE SEE BAR SCALE DRAWN BY C.COYIER DATE ISSUED APRIL 27, 2020 PVMT GRADING PINE STREET SHEET DESC.

SHEET TITLE:

C104

SHEET NUMBER # 06 of 15

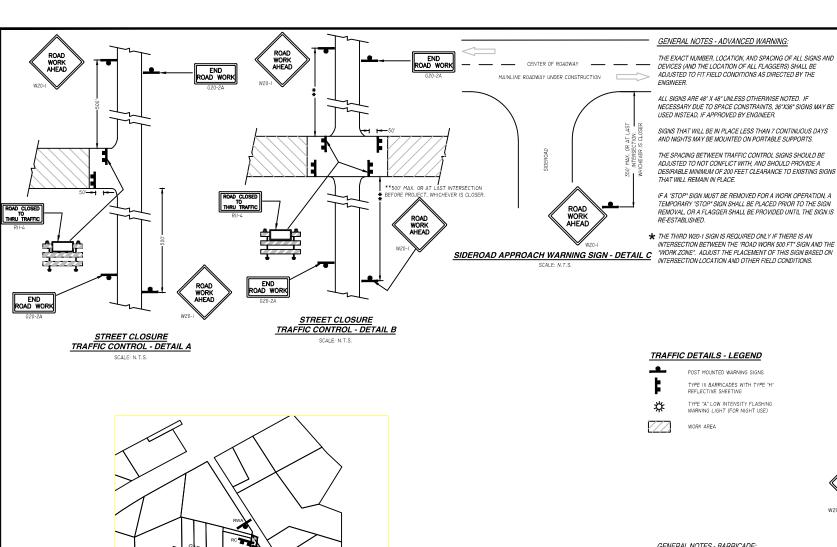

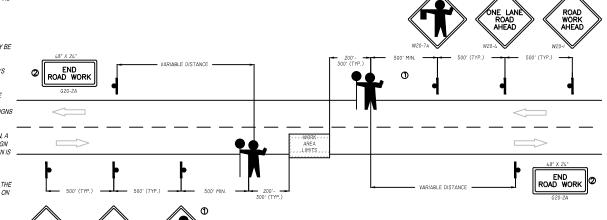

POST MOUNTED WARNING SIGNS TYPE III BARRICADES WITH TYPE "H" REFLECTIVE SHEETING

TYPE "A" LOW INTENSITY FLASHING WARNING LIGHT (FOR NIGHT USE)



WORK AREA

BE PREPARED TO STOP

SIGNING FOR BOTH DIRECTIONS SHALL BE RE-ESTABLISHED (AS SIMULTANOUSLY AS PRACTICAL) AT APPROXIMATELY
3,500 FOOT INTERVALS IN THE MOVING WORK OPERATION OR
ADVANCE OF THE ANTICIPATED TRAFFIC BACKUP OR QUEUE.

FLAGGING OPERATIONS - DETAIL E

SCALE: N.T.S.

2 SIGN NOT REQUIRED IF FLAGGING OPERATION OCCURS WITHIN A SIGNED ROAD WORK ZONE AREA.

#### GENERAL NOTES - FLAGGING OPERATIONS:

DETAILS OF TRAFFIC CONTROL DEVICES AND INSTALLATION NOT SHOWN ON THIS DRAWING SHALL CONFORM TO THE PERTINENT REQUIREMENTS OF THE WISDOT STANDARD SPECIFICATIONS, THE SPECIAL PROVISIONS, THE PLANS, THE MANUAL ON UNIFORM TRAFFIC CONTROL DEVICES, AND THE

THE EXACT NUMBER LOCATION AND SPACING OF ALL SIGNS AND DEVICES (AND THE LOCATION OF ALL FLAGGERS) SHALL BE ADJUSTED TO FIT FIELD CONDITIONS AS DIRECTED BY THE ENGINEER.

2

WHEN A SIDE ROAD OR RAMP INTERSECTS THE FACILITY ON WHICH THE WORK IS BEING PERFORMED, ADDITIONAL TRAFFIC CONTROLS SHALL BE PROVIDED AS SPECIFIED IN THE PLANS AND/OR THE SPECFICATIONS OR AS DIRECTED BY THE ENGINEER

FLAGGERS SHALL BE IN SIGHT OF EACH OTHER OR IN DIRECT COMMUNICATION AT ALL TIMES. THEY SHALL BE EQUIPPED WITH STOP/SLOW PADDLES FASTENED ON SUPPORT STAFFS. WHEN THE FLAGGING OPERATION IS NOT IN EFFECT, THE "FLAGGER AHEAD", THE "ROAD WORK AHEAD" AND THE "ONE LANE ROAD AHEAD" SIGNS SHALL BE COVERED OR REMOVED, AND THE HIGHWAY RESTORED TO NORMAL

LEGEND

WORK AREA

FLEXIBLE TUBULAR MARKER POST

POST MOUNTED SIGN

ALL SIGNS ARE 48" X 48" UNLESS OTHERWISE NOTED.

TRAFFIC TABLE A

V 4 6 8 10 (Feet)

90 120 150 220

85

120 170

280

#### GENERAL NOTES - BARRICADE:

DETAILS OF TRAFFIC CONTROL DEVICES AND THEIR LOCATION NOT SHOWN ON THIS DRAWING SHALL CONFORM TO THE PERTINENT REQUIREMENTS OF THE WISCONSIN MANUAL OF TRAFFIC CONTROL DEVICES, THE PLANS, WISDOT STANDARD SPECIFICATIONS, THE

SIGN AND BARRICADE LOCATIONS MAY BE ADJUSTED IN THE FIELD AS DIRECTED BY THE ENGINEER. ANY EXISTING TRAFFIC SIGNS THAT CONFLICT WITH THIS WORK SHALL BE COVERED AS DIRECTED BY THE ENGINEER. ALL "STOP" OR OTHER REGULATORY SIGNS ON THE SIDE ROADS SHALL NOT BE DISTURBED, EXCEPT WHEN NECESSARY TO COMPLETE THE WORK. THE SIGNS MUST THEN BE IMMEDIATELY RE-ESTABLISHED.

ALL TYPE III BARRICADES SHALL HAVE RAILS REFLECTORIZED ON BOTH FACES. STRIPES SHALL BE PROPERLY SLOPED DOWN TOWARD THE TRAFFIC SIDE OR AS SHOWN IN THE LANE CLOSURE BARRICADE DETAIL FOR FULL ROAD CLOSURES. TYPE "A" LOW INTENSITY FLASHING WARNING LIGHTS SHALL BE VISIBLE ON BOTH SIDES OF THE BARRICADE.


THE 'ROAD CLOSED' SIGN (R11-2), 'ROAD CLOSED MILES AHEAD' SIGN (R11-3), AND THE 'ROAD CLOSED TO THRU TRAFFIC' SIGN (R11-4) SHALL BE ATTACHED ONLY TO THE TOP RAIL OF THE TYPE III BARRICADE. THE SIGNS SHALL NOT COVER THE MIDDLE RAIL.

TYPE "H" REFLECTIVE SHEETING SHALL BE USED ON ALL BARRICADES, TYPE I, II, AND III, AND ON ALL R11-2, R11-3, AND R11-4 SIGNS.

ALL SIGNS SHALL BE 48" X 48" UNLESS OTHERWISE NOTED.

TWO WARNING LIGHTS SHALL BE PROVIDED ON THE CENTER BARRICADE AND AT LEAST ONE WARNING LIGHT SHALL BE PROVIDED ON EACH OF THE OTHER BARRICADES WITHIN THE ROADWAY LIMITS. SPACING OF THE WARNING LIGHTS SHALL BE UNIFORM TO THE EDGE OF ROADWAY AS SHOWN.

ONE-WAY LIGHTS SHALL BE PROVIDED ON ALL ADVANCE WARNING SIGNS. THE UNIT SHALL BE POSITIONED SUCH THAT THE LIGHT SOURCE IS OUTSIDE THE SIGN FACE AND AT THE TOP OF THE SIGN.

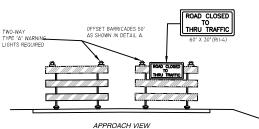

LANE CLOSURE BARRICADE - DETAIL D SCALE: N.T.S.

#### GENERAL NOTES:

USE OF THE "BE PREPARED TO STOP" SIGN IS OPTIONAL. WHEN USED, THIS SIGN SHALL BE LOCATED BETWEEN THE W20-7A AND W20-4 SIGNS. A 500" TYPICAL SPACING SHALL BE PROVIDED BETWEEN THE SIGNS.


THE EXACT NUMBER, LOCATION, AND SPACING OF ALL SIGNS AND DEVICES SHALL BE ADJUSTED TO FIT FIELD CONDITIONS AS APPROVED BY THE ENGINEER.

ALL SIGNS ARE 48"X 48" UNLESS OTHERWISE NOTED. IF NECESSARY DUE TO SPACE CONSTRAINTS IN

"WO" SIGNS ARE THE SAME AS "W" SIGNS EXCEPT THE BACKGROUND IS ORANGE.

 $\textit{SIGNS THAT WILL BE IN PLACE LESS THAN 7 CONTINUOUS DAYS AND NIGHTS MAY BE MOUNTED ON \\$ 

WHERE THESE SIGNS ARE ALREADY PRESENT. 020-2A SIGNS MAY ALSO BE OMITTED IF DURATION OF WORK IS LESS THEN 7 CONTINUOUS DAYS AND NIGHTS.

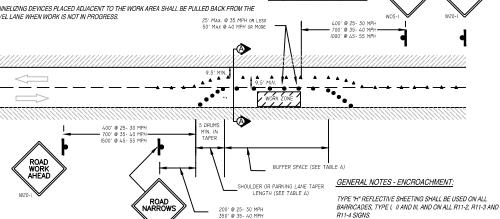

TRAFFIC ENCROACHMENT - DETAIL F

SCALE: N.T.S.

ALL SIGNS SHALL BE 48" X 48" UNLESS OTHERWISE NOTED BELOW: .. R11-2 "ROAD CLOSED" SIGNS SHALL BE 48" X 30"

R11-3, AND R11-4 SIGNS SHALL BE 60" X 30". G20-2A SIGNS SHALL BE 48" X 24".

ROPOSED 2020 INFRASTRUCTUR IMPROVEMENTS - PINE STREET

**POINT,** I

MINERAL , LOCATION: PINE STREET MINERAL POINT; 137 HIGH

A DELTA 3

875 SOUTH CHESTNUT STREET PHONE: (608) 348-5355 PLATTEVILLE, WISCONSIN 53818

FOR QUESTIONS REGARDING THIS PROJECT, PLEASE CONTACT:

MR. MARK DIGMAN, P.E.

DELTA 3 ENGINEERING INC. TELEPHONE: (608) 348-5355

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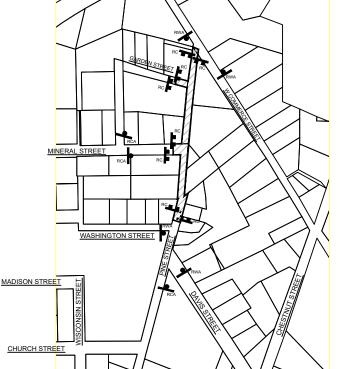
4S-BUILT

PROJECT NUMBER D20-001 SHEET SCALE NOT TO SCALE DRAWN BY C. COYIER APRIL 27, 2020 DETAILS - TRAFFI SHEET DESC. CONTROL, MAP. & NO

SHEET TITLE:

C201

NUMBER # 07 of 15



TRAFFIC CONTROL GUIDE MAPS

THE SIGN LOCATIONS SHOWN ARE APPROXIMATE LOCATIONS. THE CONTRACTOR SHALL INSTALL TRAFFIC CONTROL SIGNS PER WISCONSIN STANDARDS AND THE MANUAL OF UNIFORM TRAFFIC CONTROL DEVICES (MUTCD).

THE SIGNS SHOWN ARE THE MINIMUM TRAFFIC CONTROL THAT WILL BE REQUIRED FOR THE PROJECT. THE CONTRACTOR SHALL BE RESPONSIBLE FOR PROVIDING ADDITIONAL TRAFFIC CONTROL MEASURES DURING CONSTRUCTION TO MEET THE STANDARDS OF UNIFORM TRAFFIC CONTROL DEVICES, AND AS DIRECTED BY THE PROJECT ENGINEER

URBAN AREAS, 36"X 36" SIGNS MAY BE USED IF APPROVED BY THE ENGINEER.


ANY SIGNS TEMPORARY OR EXISTING. WHICH CONFLICT WITH TRAFFIC CONTROL "IN USE". SHALL BE REMOVED OR COVERED AS NEEDED AND AS APPROVED BY THE ENGINEER.

W20-1 AND G20-2A SIGNS ARE NOT REQUIRED IF THE WORK AREA IS WITHIN A LARGER WORK ZONE

CHANNELIZING DEVICES PLACED ADJACENT TO THE WORK AREA SHALL BE PULLED BACK FROM THE

## EROSION CONTROL SEDIMENT LOG



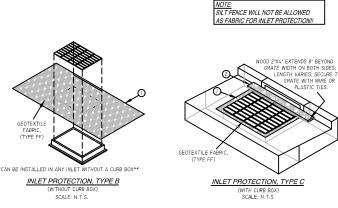

## INLET PROTECTION DETAILS

#### INSTALLATION NOTES:

TRIM EXCESS FABRIC IN THE FLOW TO WITHIN 3" OF GRATE. THE CONTRACTOR SHALL DEMONSTRATE A METHOD OF MAINTENANCE USING A SEWN FLAP, HAND HOLDS OR OTHER METHOD TO PREVENT ACCUMULATED SEDIMENT FROM ENTERING THE INLET.

DO NOT INSTALL PROTECTION TYPE D IN INLETS SHALLOWER THAN 30°, MEASURED FROM THE BOTTOM OF THE INLET TO THE TOP OF THE GRATE. TRIM EXCESS FABRIC IN THE FLOW LINE TO WITHIN 3' OF THE GRATE. THE INSTALLED BAG SHALL HAVE A MINIMUM SIDE CLEARANCE, BETWEEN THE INLET WALLS AND THE BAG, MEASURED AT THE BOTTOM OF THE OVERFLOW HOLES, OF 3", WHERE NECESSARY. THE CONTRACTOR SHALL CINCH THE BAG, USING PLASTIC ZIP TIES, TO ACHIEVE THE 3" CLEARANCE. THE TIES SHALL BE PLACED AT A MAXIMUM OF 4" FROM THE BOTTOM OF THE BAG.

## GENERAL NOTES-INLET PROTECTION.

INLET PROTECTION DEVICES SHALL BE MAINTAINED OR REPLACED AT THE DIRECTION OF THE ENGINEER.

MANUFACTURED ALTERNATIVES APPROVED AND LISTED ON THE DEPARTMENTS EROSION CONTROL PRODUCT ACCEPTABILITY LIST MAY BE SUBSTITUTED.

INLET PROTECTION - TYPE D


INSTALLED IN ANY INLET WITH OF A CURB BOX AS PER NOTE (2)

WHEN REMOVING OR MAINTAINING INLET PROTECTION, CARE SHALL BE TAKEN SO THAT THE SEDIMENT TRAPPED ON THE GEOTEXTILE FABRIC DOES NOT FALL INTO THE INLET, ANY MATERIAL FALLING INTO THE INLET SHALL BE REMOVED

TRINISHED SIZE, INCLUDING FLAP POCKETS WHERE REQUIRED, SHALL EXTEND A MIN. OF 10\* AROUND THE PERIMETER TO FACILITATE MAINTENANCE OR REMOVAL.

2) FOR INLET PROTECTION, TYPE C (WITH CURB BOX), AN ADDITIONAL 18" OF FABRIC IS WRAPPED AROUND THE WOOD AND SECURED WITH STAPLES. THE WOOD SHALL NOT BLOCK THE ENTIRE HEIGHT OF THE CURB BOX OPENING.

(3) FLAP POCKETS SHALL BE LARGE ENOUGH TO ACCEPT WOOD 2"X4"

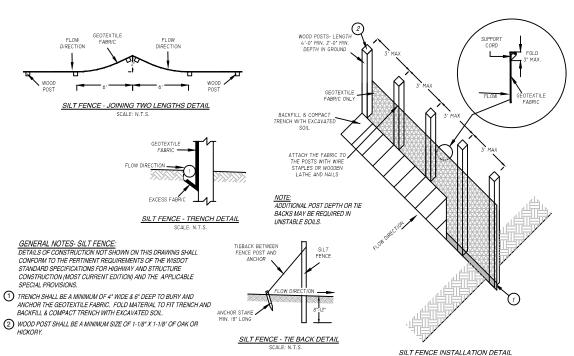

#### SILT FENCE DETAILS

#### REGRADED DITCH DETAIL

END 10" BEYOND GRATE WIDTH ON BOTH SIDES GTH VARIES; SECURE TO GRATE WITH WIRE OF

MIN DOUBLE STITCHED SEAMS AL

EROSION MATTING NOTES:

1. PREPARE SOIL BEFORE INSTALLING BLANKETS, INCLUDING APPLICATION OF FERTILIZER AND MULCH AND SEED.

2. BEGIN AT THE TOP OF THE SHOULDER (OR CHANNEL) BY ANCHORING THE BLANKET IN A 6" DEEP X 6" WIDE TRENCH. BACKFILL

- AND COMPACT THE TRENCH AFTER STAPLING
- ROLL THE BLANKETS DOWN (STARTING AT DOWNSTREAM PROCEEDING UPSTREAM) HORIZONTALLY ACROSS THE SLOPE.
  THE EDGES OF PARALLEL BLANKETS MUST BE STAPLED WITH MANUFACTURE'S RECOMENDED OVERLAP.
- 5. WHEN BLANKETS MUST BE SPLICED DOWN THE SLOPE, PLACE BLANKETS END OVER END (SHINGLE STYLE) WITH AN OVERLAP,
- USE A DOUBLE ROW OF STAGGERED STAPLES 4" APART TO SECURE BLANKETS.
  6. IN HIGH CHANNEL APPLICATIONS, A STAPLE SLOT IS RECOMMENDED AT 30 TO 40 FOOT INTERVALS. USE A ROW OF STAPLES 4"
- APART OVER THE ENTIRE WIDTH OF THE CHANNEL PLACE A SECOND ROW 4" BELOW THE FIRST ROW IN A STAGERED PATTERN. 7. THE TERMINAL END OF THE BLANKETS MUST BE ANCHORED IN A 6" DEEP X 6" WIDE TRENCH. BACKFILL AND COMPACT THE

EROSION MATTING - SLOPE INSTALLATION DETAIL

#### **EROSION CONTROL NOTES:**

GENERAL EROSION NOTES AND MAINTENANCE MEASURES ARE ILLUSTRATED ON THE PLAN & PROFILE SHEETS. AFTER AWARD OF THE CONTRACT, THE GENERAL CONTRACTOR SHALL INSTALL ALL BEST MANAGEMENT PRACTICES AS SHOWN ON THE PLAN & PROFILE SHEETS. ONCE INSTALLED, THE GENERAL CONTRACTOR SHALL CONTACT DELTA 3 ENGINEERING, INC. (608-348-5355). ONCE NOTIFIED DELTA 3 ENGINEERING INC. WILL VISIT THE SITE WITHIN 5 DAYS TO REVIEW THE SITE SPALL CONTACT DELTA'S ENGINEERING, INC., (000-306-3033). ONCE NOTIFIED DELTA'S ENGINEERING INCLL VISIT THE STEE WITHIN S DATS TO REVIEW THE STEE WITH THE GENERAL CONTRACTORS SUPERINTENDENT WILL REVIEW THE STEE FOR COMPLIANCE WITH THE ERSON CONTROL MEASURES. IF AND WHEN ALL BEST MANAGEMENT PRACTICES REQUIRED TO COMMENCE SITE CONSULTING ENGINEERING AND CERTIFY THIS REVIEW AND STEE CONSULTING ENGINEER AND PRACTICES WERE THE STEE OF THE STEEL OF THE STEE OF THE STEE OF THE STEE OF THE STEE OF THE STEED OF THE STEE OF THE STEE OF THE STEE OF THE STEEL OF THE STEE OF THE STEE OF THE STEE OF THE STEEL OF THE CERTIFICATION SHALL TAKE PLACE PRIOR TO THE REQUIRED PRE-CONSTRUCTION MEETING. THE SITE SUPERINTENDENT SHALL MAINTAIN AN AS-BUILT COPY OF THE EROSION CONTROL MEASURES ON SITE AT ALL TIMES. ANY ACTIVITIES INVOLVING INSTALLATION OF BEST MANAGEMENT PRACTICES SHALL BE INDICATED ON THE AS-BUILT PLAN WITH AN INSTALLED TIME AND DATE. RECORDED INFORMATION SHALL BE PERMANENTLY PLACED ON THE SITE MAP INCLUDING ANY CHANGES MADE TO THE BEST MANAGEMENT PRACTICES. IF THE SITE MAP BECOMES HARD TO READ, THE INITIAL DRAWING SHALL BE SAVED AND A CLEAN COPY SHALL BE

A COMPLETE COPY OF ALL INSPECTION REPORTS, PLAN REVISIONS, ETC., MUST BE RETAINED AT THE PROJECT SITE AT ALL TIMES DURING DURATION OF THE PROJECT AND KEPT IN THE PERMANENT PROJECT RECORDS FOR AT LEAST FIVE YEARS FOLLOWING SUBMISSION OF THE NOTICE OF TERMINATION (NOT

THE GENERAL CONTRACTOR SHALL BE RESPONSIBLE FOR INSURING THAT ALL SUB-CONTRACTORS INVOLVED IN GROUND DISTURBING ACTIVITY COMPLY WITH THE

DAILY INSPECTIONS BY THE PROJECT SUPERINTENDENT AND MONTHLY INSPECTIONS BY THE OWNER'S CONSTRUCTION MANAGER MUST BE MADE TO DETERMINI THE EFFECTIVENESS OF THE EROSION CONTROL MEASURES. THE GENERAL CONTRACTOR IS TO INSPECT EROSION AND SEDIMENT CONTROLS WITHIN 24 HOURS
AFTER A RAINFALL EVENT OF 0.5 INCHES OR GREATER. THE GENERAL CONTRACTOR SHALL BE RESPONSIBLE TO REPAIR OR REPLACE EROSION AND SEDIMENT CONTROL BEST MANAGEMENT PRACTICES AS NECESSARY WITHIN 24 HOURS OF INSPECTION.

ONCE THE SITE REACHES FINAL STABILIZATION, ALL PERMANENT EROSION AND SEDIMENTATION CONTROLS ARE INSTALLED AND ALL TEMPORARY EROSION AND SEDIMENTATION CONTROLS ARE REMOVED, THE GENERAL CONTRACTOR AND DWINER MUST COMPLETE A FINAL SITE INSPECTION. UPON APPROVAL BY OWNER, THE OWNER AND GENERAL CONTRACTOR, AS APPLICABLE, MUST COMPLETE AND SUBMIT A NOTICE OF TERMINATION (NOT) FORM TO BE SUBMITTED TO THE WISCONSIN DEPARTMENT OF NATURAL RESOURCES.

A RECORD OF THE DATES WHEN MAJOR GROUND-DISTURBING ACTIVITIES OCCUR, WHEN CONSTRUCTION ACTIVITIES TEMPORARILY OR PERMANENTLY CEASE ON A PORTION OF THE SITE, AND WHEN STABILIZATION MEASURES ARE INITIATED MUST BE MAINTAINED UNTIL THE NOT IS FILED. CONTROLS MUST BE IN PLACE DOWN GRADIENT OF GROUND-DISTURBING ACTIVITIES PRIOR TO THE COMMENCEMENT OF CONSTRUCTION.

A LOG OF ALL INSPECTIONS BY FEDERAL STATE OR LOCAL STORM WATER OR OTHER ENVIRONMENTAL AGENCIES SHALL BE KEPT BY THE GENERAL CONTRACTOR THE LOG SHALL INCLUDE THE DATE AND TIME OF VISIT AND WHETHER A REPORT WAS ISSUED OR WILL BE ISSUED AS A RESULT OF THE INSPECTION. AN REPORTS ISSUED SHALL BE FAXED TO THE DELTA 3 ENGINEERING INC. 608-348-5455 (FAX).

SOIL STABILIZATION - THE PURPOSE OF SOIL STABILIZATION IS TO PREVENT SOIL FROM LEAVING THE SITE. IN THE NATURAL CONDITION, SOIL IS STABILIZED BY NATIVE VEGETATION. THE PRIMARY TECHNIQUE TO BE USED AT THIS PROJECT FOR STABILIZING SITE SOIL WILL BE TO PROVIDE A PROTECTIVE COVER OF TURK GRASS OR PAVEMENT

TEMPORARY SEEDING OR STABILIZATION - AREAS MAY BE STABILIZED TEMPORARILY WITH THE USE OF FAST-GERMINATING ANNUAL SEED, STRAW MULCH, WOOD CELLULOSE FIBERS, TACKIFIERS, NETTING OR BLANKET. WHERE CONDITIONS ARE FAVORABLE, AREAS SHALL BE TEMPORARILY STABILIZED WITHIN 7 DAYS AFTER CONSTRUCTION ACTIVITY CEASES. ALL DISTURBED GROUND WHERE THERE WILL NOT BE CONSTRUCTION FOR LONGER THAN 14 DAYS MUST BE

(B) PERMANENT SEEDING OR SOD - ALL AREAS AT FINAL GRADE MUST BE SEEDED OR SODDED WITHIN 3 DAYS AFTER COMPLETION OF THE MAJOR CONSTRUCTION ACTIVITY. EXCEPT FOR SMALL LEVEL SPOTS, SEEDED AREAS SHOULD GENERALLY BE PROTECTED WITH MULCH. ALL AREAS TO BE SEEDED WILL ALSO HAVE TOPSOIL AND OTHER AMENDMENTS AS STATED IN WISDOT SPECIFICATION SECTION 02900-PLANTING.

(C) MULCHING - ALL AREAS THAT ARE TEMPORARY OR PERMANENT SEEDED SHALL BE MULCHED ACCORDING TO SECTION 627 - MULCHING OF THE WISDOT STANDARD SPECIFICATIONS FOR HIGHWAY CONSTRUCTION. ALL MULCH IS TO BE ANCHORED UTILIZING METHOD A. B. OR C.

(D) EROSION CONTROL MATTING - FOR ANY SLOPES GREATER THAN 3:1, EROSION MATTING IS REQUIRED.

STRUCTURAL CONTROLS - BEFORE ANY MAJOR GRADING ACTIVITIES, THE FOLLOWING BEST MANAGEMENT PRACTICES SHALL BE INSTALLED ON THE PROPOSED SITE - SILT FENCE, TEMPORARY TRACKING PAD, AND STORM SEWER INLET PROTECTION.

(A) SILT FENCE - SILT FENCE IS A SYNTHETIC PERMEABLE WOVEN OR NON-WOVEN FABRIC TYPICALLY INCORPORATING WOODEN OR METAL SUPPORT STAKES AT THERMALS SUFFICIENT TO SUPPORT THE FENCE, WATER, AND SEDIMENT RETAINED BY THE FENCE. SLIT FENCE. CAN ALSO BE INSTALLED WITH A WINE FENCE BACKING. THE FENCE IS DESIGNED TO RETAIN SEDIMENT-LADEN WATER AND ALLOW SETTLEMENT OF SUSPENDED SOILS BEFORE THE STORM WATER AND ALLOW SETTLEMENT OF SUSPENDED SOILS BEFORE THE STORM WATER FLOWS THROUGH THE FABRIC FOR DISCHARGE DOWNSTREAM. SLIT FENCE SHALL BE LOCATED AS SHOWN ON THE PLAN & PROPILE SHEETS. THE SLIT FENCE TO BE INCLUDED FOR THIS PROJECT SHALL BE CONSTRUCTED PER WISCONSIN DAR TECHNICAL STANDARDS FOR SLIT FENCE (CODE 1056).

(B) TEMPORARY TRACKING PAD - ALL ACCESS POINTS FROM THE PUBLIC STREET INTO THE CONSTRUCTION SITE SHALL INCLUDE A TRACKING PAD COMPOSED OF COURSE STONE TO THE DIMENSIONS SHOWN ON DETAIL SHEET (COO2). ANY SEDIMENT REACHING A PUBLIC OR PRIVATE ROAD SHALL BE REMOVED BY STREET CLEANING (NOT FLUSHING) BEFORE THE END OF EACH WORKDAY.

(C) STORM SEWER INLET PROTECTION - CURB AND GRATED INLETS ARE PROTECTED FROM THE INTRUSION OF SILT AND SEDIMENT THROUGH A VARIETY OF SEDIMENT CONTROL PRACTICES TO ALLOW SETTLEMENT OF SUSPENDES DISIG BEFORE DISCHARGING INTO THE STORM SEVERE, BRATED INLETS TYPICALLY INCLUDE A STURDY FRAME WRAPPED IN GEOTEXTILE FABRIC OR SEDIMENT LOG PERIMETER TO SLOW THE FLOW OF WATER AND ALLOW PONDING WHERE SEDIMENT MAY SETTLE OUT. CURB INLETS TYPICALLY INCLUDE SEDIMENT LOG BARRIERS HELD IN PLACE WITH GEOTEXTILE FABRIC. OTHER MANUFACTURED PRODUCTS ARE ALSO AVAILABLE. ALL STORM DRAINS SHALL BE PROTECTED BY USING STRAW BALES, SEDIMENT LOGS, FABRIC, OR EQUIVALENT BARRIER.

FINAL SITE STABILIZATION IS ACHIEVED WHEN TURF GRASS COVER PROVIDES PERMANENT STABILIZATION FOR AT LEAST 70 PERCENT OF THE DISTURBED SOIL SURFACE, EXCLUSIVE OF AREAS THAT HAVE BEEN PAVED.

#### 10. OTHER POLLUTANT CONTROLS

(A) DUST CONTROL - CONSTRUCTION TRAFFIC MUST ENTER AND EXIT THE SITE AT THE STABILIZED CONSTRUCTION EXIT. THE PURPOSE IS TO TRAP DUST AND MUD THAT WOULD OTHERWISE BE CARRIED OFF-SITE BY CONSTRUCTION EQUIPMENT.

WATER TRUCKS OR OTHER DUST CONTROL AGENTS WILL BE USED AS NEEDED DURING CONSTRUCTION TO REDUCE DUST GENERATED ON THE SITE. DUST CONTROL MUST BE PROVIDED BY THE GENERAL CONTRACTOR TO A DEGREE THAT IS ACCEPTABLE TO THE OWNERS CONSTRUCTION MANAGER, AND IN COMPLIANCE WITH APPLICABLE LOCAL AND STATE DUST CONTROL REGULATIONS. AFTER CONSTRUCTION, THE SITE WILL BE STABILIZED (AS DESCRIBED ELSEWHERE), WHICH WILL REDUCE THE POTENTIAL FOR DUST GENERATION.

(B) SOLID WASTE DISPOSAL - NO SOLID MATERIALS, INCLUDING BUILDING MATERIALS, ARE ALLOWED TO BE DISCHARGED FROM THE SITE WITH STORM WATER. ALL SOLID WASTE, INCLUDING DISPOSABLE MATERIALS INCIDENTAL TO THE MAJOR CONSTRUCTION ACTIVITIES, MUST BE COLLECTED AND PLACED IN CONTAINERS. THE CONTAINERS WILL BE EMPTIED AS NECESSARY BY A CONTRACT TRASH DISPOSAL SERVICE AND HAULED AWAY FROM THE SITE. THE LOCATION OF SOLID WASTE RECEPTACLES SHALL BE SHOWN AND APPROVED BY THE OWNER.

SUBSTANCES THAT HAVE THE POTENTIAL FOR POLLUTING SURFACE AND/OR GROUNDWATER MUST BE CONTROLLED BY WHATEVER MEANS NECESSARY IN ORDER TO ENSURE THAT THEY DO NOT DISCHARGE FROM THE SITE. FOR EXAMPLE, SPECIAL CARE MUST BE EXERCISED DURING EQUIPMENT FUELING AND SERVICING OPERATIONS. IF A SPILL OCCURS, IT MUST BE CONTAINED AND DISPOSED SO THAT IT WILL NOT FLOW FROM THE SITE OR ENTER GROUNDWATER, EVEN IF THIS REQUIRES REMOVAL, TREATMENT, AND DISPOSAL OF SOIL. IN THIS REGARD, POTENTIALLY POLLUTING SUBSTANCES SHOULD BE HANDLED IN A MANNER CONSISTENT WITH THE IMPACT THEY REPRESENT

(C) SANTARY FACILITIES - ALL PERSONNEL INVOLVED WITH CONSTRUCTION ACTIVITIES MUST COMPLY WITH STATE AND LOCAL SANITARY OR SEPTIC SYSTEM REGULATIONS. TEMPORARY SANITARY FACILITIES MUST BE PROVIDED AT THE SITE THROUGHOUT THE CONSTRUCTION PHASE. THEY MUST BE UTILIZED BY ALL CONSTRUCTION PERSONNEL AND MUST BE SERVICED BY A COMMERCIAL OPERATOR.

(D) WATER SOURCE · NON-STORM WATER COMPONENTS OF SITE DISCHARGE MUST BE CLEAN WATER. WATER USED FOR CONSTRUCTION WHICH DISCHARGES FROM THE SITE MUST OF HIGH THE OWNER OWNER THE SITE DESCRIPTION TO BE ADMINISTRATED THE VIGET FOR OWNER THE SITE OF THE SITE HEALTH DEPARTMENT. WATER USED FOR CONSTRUCTION THAT DOES NOT ORIGINATE FROM A PUBLIC WATER SUPPLIER, OR PRIMATE WELL APPROVED BY THE STATE HEALTH DEPARTMENT. WATER USED FOR CONSTRUCTION THAT DOES NOT ORIGINATE FROM AN APPROVED PUBLIC SUPPLY MUST NOT DISCHARGE FROM THE SITE. IT CAN BE RETAINED IN THE POWDS UNTIL IT INPLITATES AND EVAPORATES.

(E) CONCRETE WASTE FROM CONCRETE READY-MIX TRUCKS - DISCHARGE OF EXCESS OR WASTE CONCRETE AND/OR WASH WATER FROM CONCRETE TRUCKS UNIO, LE MAJE : PUNIO COMMENTE PUNIO STEE, BUT ONLY IN SPECIFICALLY DESIGNATED DIKED AREAS PREPARED TO PREVENT CONTACT BETWEEN THE CONCRETE ANDOWN WASH WATER AND STORM WATER THAT WILL BE DISCHARGED FROM THE SITE. ALTERNATIVELY, WASTE CONCRETE CAND BE PLACED INTO FORMS TO MAKE RIP-RAP OR OTHER USEFUL CONCRETE CAND BE PLACED INTO FORMS TO MAKE RIP-RAP OR OTHER USEFUL CONCRETE PRODUCTS. THE CURDE RESIDUE FROM THE CONCRETE WASHOUT DIKED AREAS SHALL BE DISPOSED IN ACCORDANCE WITH APPLICABLE STATE AND FEDERAL REGULATIONS. THE JOB SITE SUPERINTENDENT IS RESPONSIBLE FOR ASSURING THAT

(F) FUEL TANKS - TEMPORARY ON-SITE FUEL TANKS FOR CONSTRUCTION VEHICLES SHALL MEET ALL STATE AND FEDERAL REGULATIONS. TANKS SHALL HAVE FIGURE 17 THINGS - I EMPOYANT ON-OTHER FUNDED FOR CONSTRUCTION OF PERIOLES STATE MEET ALL OTHER AND PEDERAIL REQUILIDATION. AND STALL HAVE A PROVINCE DEVILE AND FUNDED FOR THE AND FEDERAL REGULATIONS. THE TANK SHALL BE IN SOUND CONDITION FREE OF PUST OR OTHER DAMAGE WHICH MIGHT COMPROMISE CONTAINMENT. HOSES, VALVES, FITTINGS, CAPS, FILLER NOZZLES, AND ASSOCIATED HARDWARE SHALL BE MAINTAINED IN PROPER WORKING CONDITION AT ALL TIMES.

MINIMIZING EROSION AND RUNOFF DURING TRENCH OPERATIONS

(A) EXCAVATED TRENCH MATERIALS SHALL BE PLACED ON THE UPPER SIDE OF THE TRENCH WHILE THE TRENCH IS OPEN.

EXCAVATED TRENCH MATERIAL, UPON COMPLETING WORK IN TRENCH, SHALL BE PLACED BACK IN THE TRENCH OR HAULED AWAY TO A PROPER SPOIL SITE. THE TRENCH SHALL BE BACKFILLED AND STABILIZED AT THE END OF EACH WORKING DAY.

ENGINEER:

DELTA 3

875 SOUTH CHESTNUT STREET PHONE: (608) 348-5355 PLATTEVILLE, WISCONSIN 53818 PHONE: (563) 542-9005 898 JACKSON STREET Dubuque, Iowa 52001

FOR QUESTIONS REGARDING THIS PROJECT, PLEASE CONTACT:

MR. MARK DIGMAN, P.E. DELTA 3 ENGINEERING INC TELEPHONE: (608) 348-5355

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TRUCTURE STREET

 $\geq$ **POINT,** (W. COMMERCE SH STREET, SUITE

ROPOSED 2020 INFRAS: IMPROVEMENTS - PINE


FOR BID PROJECT NUMBER D20-001 SHEET SCALE NOT TO SCALE DRAWN BY C.COYIER DATE ISSUED APRIL 27, 2020 DETAILS - EROSIC SHEET DESC. CONTROL & NOTES

SHEET TITLE:

4S-BUILT

C202

NUMBER # 08 of 15

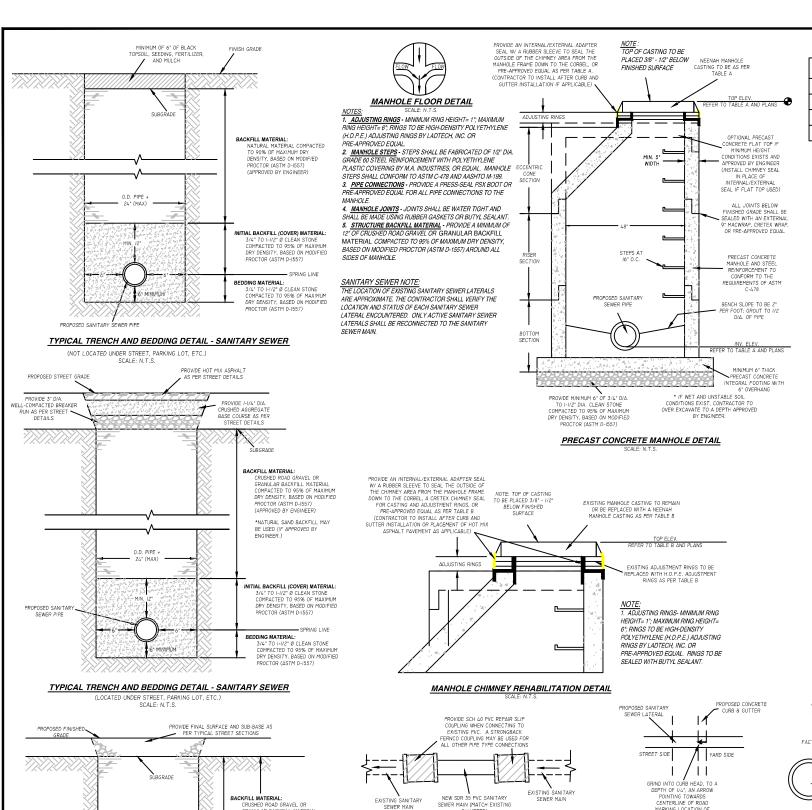

DIAMETER)

SANITARY SEWER MAIN SPOT REPAIR/CONNECTION DETAIL

SCALE: N.T.S.

CRUSHED ROAD GRAVEL OR GRANULAR BACKFILL MATERIAL COMPACTED TO 95% OF MAXIMUM DRY DENSITY, BASED ON MODIFIED PROCTOR (ASTM D-1557) (APPROVED BY ENGINEER)

\*NATURAL SAND BACKFILL MAY BE USED (IF APPROVED BY ENGINEER.)

INITIAL BACKFILL (COVER) MATERIAL:
- SEWER - 3/4" TO 1-1/2" Ø CLEAN STONE
- WATER - CRUSHED STONE CHIPS, CRUSHED

BASED ON MODIFIED PROCTOR (ASTM D-1557) SPRING LINE

BEDDING MATERIAL:

- SEWER - 5/4' TO I-I/2' Ø CLEAN STONE

- WATER - CRUSHED STONE CHIPS, CRUSHED

STONE SCREENINGS OR BEDDING SAND

COMPACTED TO 95% OF MAXIMUM DRY DENSITY,


BASED ON MODIFIED PROCTOR (ASTM D-1557)

OR <30° IF WATER SERVICE


**DUAL SERVICE TRENCH DETAIL** 

PROPOSED TYPE "K" COPPER ...


WATER SERVICE (SEE PLAN SHEETS FOR SIZE)

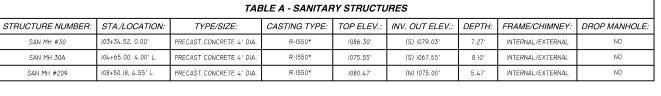


NOTE: CASTING TO BE NEENAH, NON-ROCKING CASTING WITH A SELF SEALING, TYPE "B" LID WITH SEALED PICK HOLES. \*\* NOTE: ALL ADJUSTMENT RINGS TO BE HDPE ADJUSTING RINGS BY LADTECH, INC. OR PRE-APPROVED EQUAL.

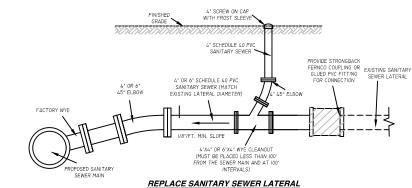

## AND INSTALL CLEANOUT DETAIL

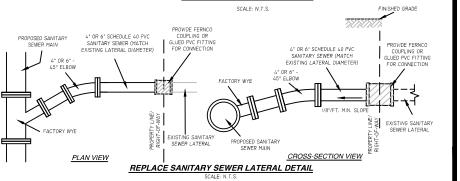

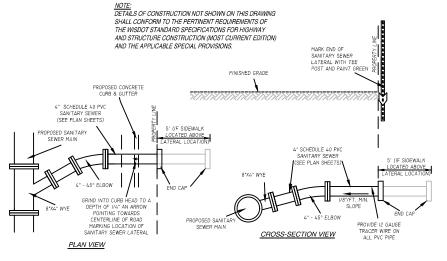

#### NEW 4" SANITARY SEWER LATERAL DETAIL

, ,	CAMITAIN CENE	, LA , L , ,
	SCALE: N.T.S	

TABLE B - REHBILITATED /ADJUSTED MANHOLES						
STRUCTURE NUMBER:	STA./LOCATION:	TYPE/SIZE:	EX. TOP ELEV.:	PROP. TOP ELEV.:	CHANGE:	COMMENTS:
SAN MH #27A	106+24.91, 1.52' L	4' DIA. PRECAST	1072.13'	1,072.191	+0.06'	UTILIZE EXISTING CASTING. REMOVE AND REPLACE EXISTING ADJUSTMENT RINGS. REMOVE AND REINSTALL CHIMNEY SEAL.

\*\* NOTE: ALL ADJUSTMENT RINGS TO BE HOPE ADJUSTING RINGS BY LADTECH INC. OR PRE-APPROVED FOUAL

RECONNECT SANITARY SEWER LATERAL DETAIL

SEWER LATERAL MARKING DETAIL

SCALE: N.T.S

ENGINEER:

DELTA 3

875 SOUTH CHESTNUT STREET PHONE: (608) 348-5355 PLATTEVILLE, WISCONSIN 53818 898 Jackson Street Dubuque, Iowa 52001 PHONE: (563) 542-9005

FOR QUESTIONS REGARDING THIS PROJECT, PLEASE CONTACT:

MR. MARK DIGMAN, P.E. DELTA 3 ENGINEERING INC. TELEPHONE: (608) 348-5355

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> INFRASTRUCTUR 'S - PINE STREET PROPOSED 2020 IN IMPROVEMENTS

W F- WASHING MINERAL I

MINERAL POINT, ATION: PINE STREET (W. COMMERCE ST. SRAL POINT; 137 HIGH STREET, SUITE 1.


4S-BUILT:

PROJECT NUMBER D20-001 SHEET SCALE NOT TO SCALE DRAWN BY C.COYIER DATE ISSUED APRIL 27, 2020 DETAILS - SANITAR SHEET DESC. SEWER SYSTEM

SHEET TITLE:

C203

NUMBER # 09 of 15

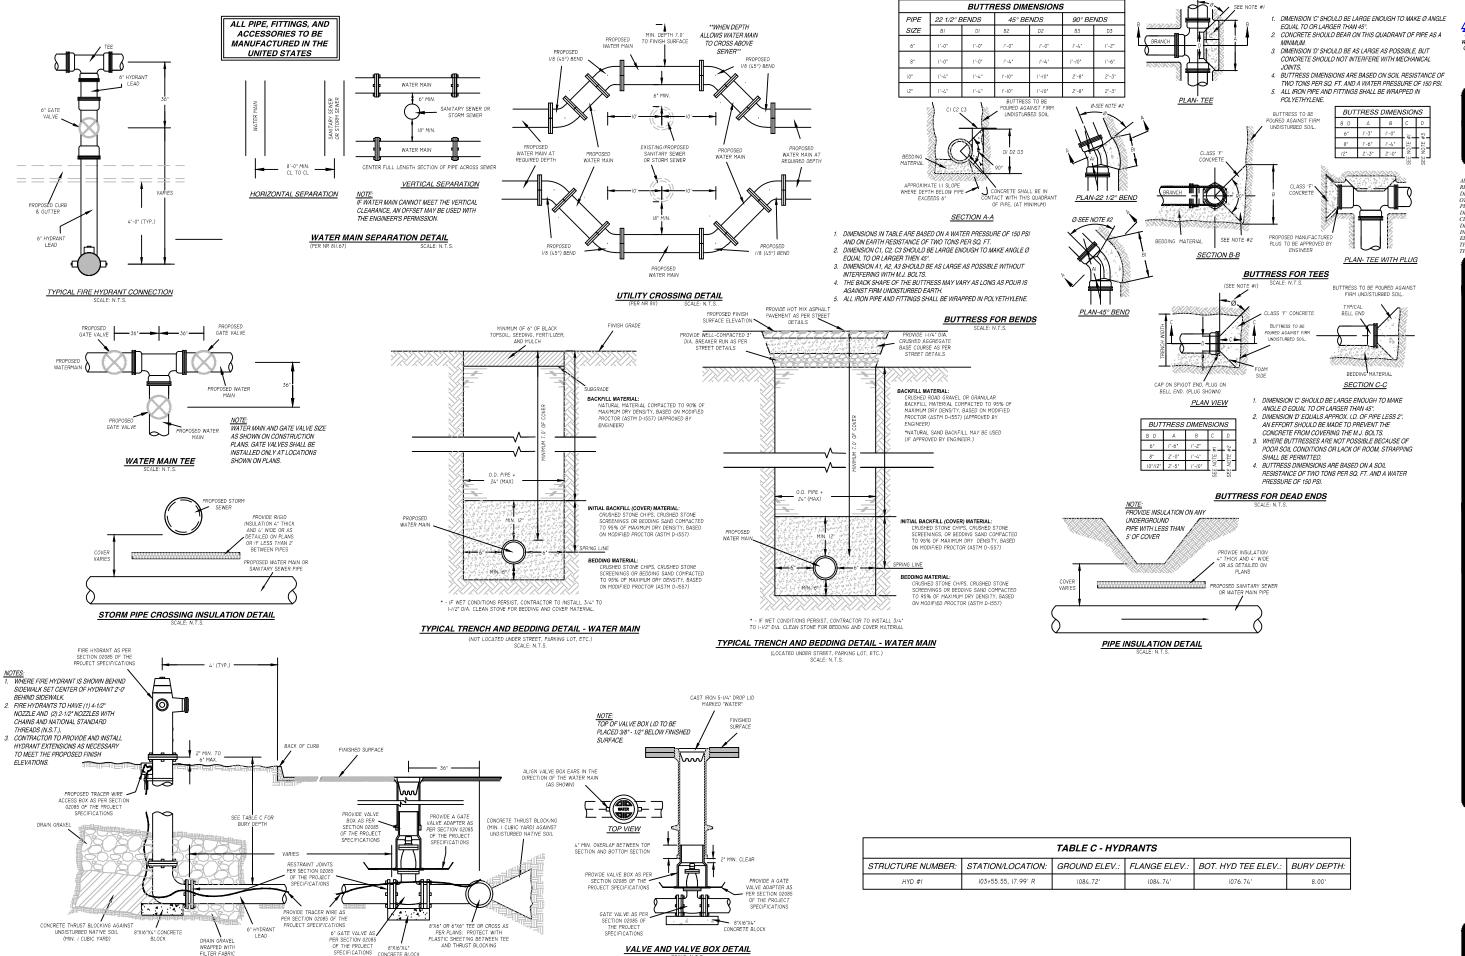

FIRE HYDRANT ASSEMBLY DETAIL

ENGINEER:

DELTA 3

875 SOUTH CHESTNUT STREET PHONE: (608) 348-5355 PLATTEVILLE, WISCONSIN 53818

PHONE: (563) 542-9005 898 JACKSON STREET DUBUQUE, KWA 52001

FOR QUESTIONS REGARDING THIS PROJECT, PLEASE CONTACT:

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PROPOSED 2020 INFRASTRUCTURE IMPROVEMENTS - PINE STREET MINERAL POINT, WI ATION: PINE STREET (W. COMMERCE ST. WASHIN SPAL POINT; 137 HIGH STREET, SUITE 1, MINERAL


AS-BUILT:

FOR BID PROJECT NUMBER D20-001 SHEET SCALE NOT TO SCALE DRAWN BY C. COYIER DATE ISSUED APRIL 27, 2020 DETAILS - WATER SHEET DESC. SYSTEM

SHEET TITLE:

C204

NUMBER # 10 of 15

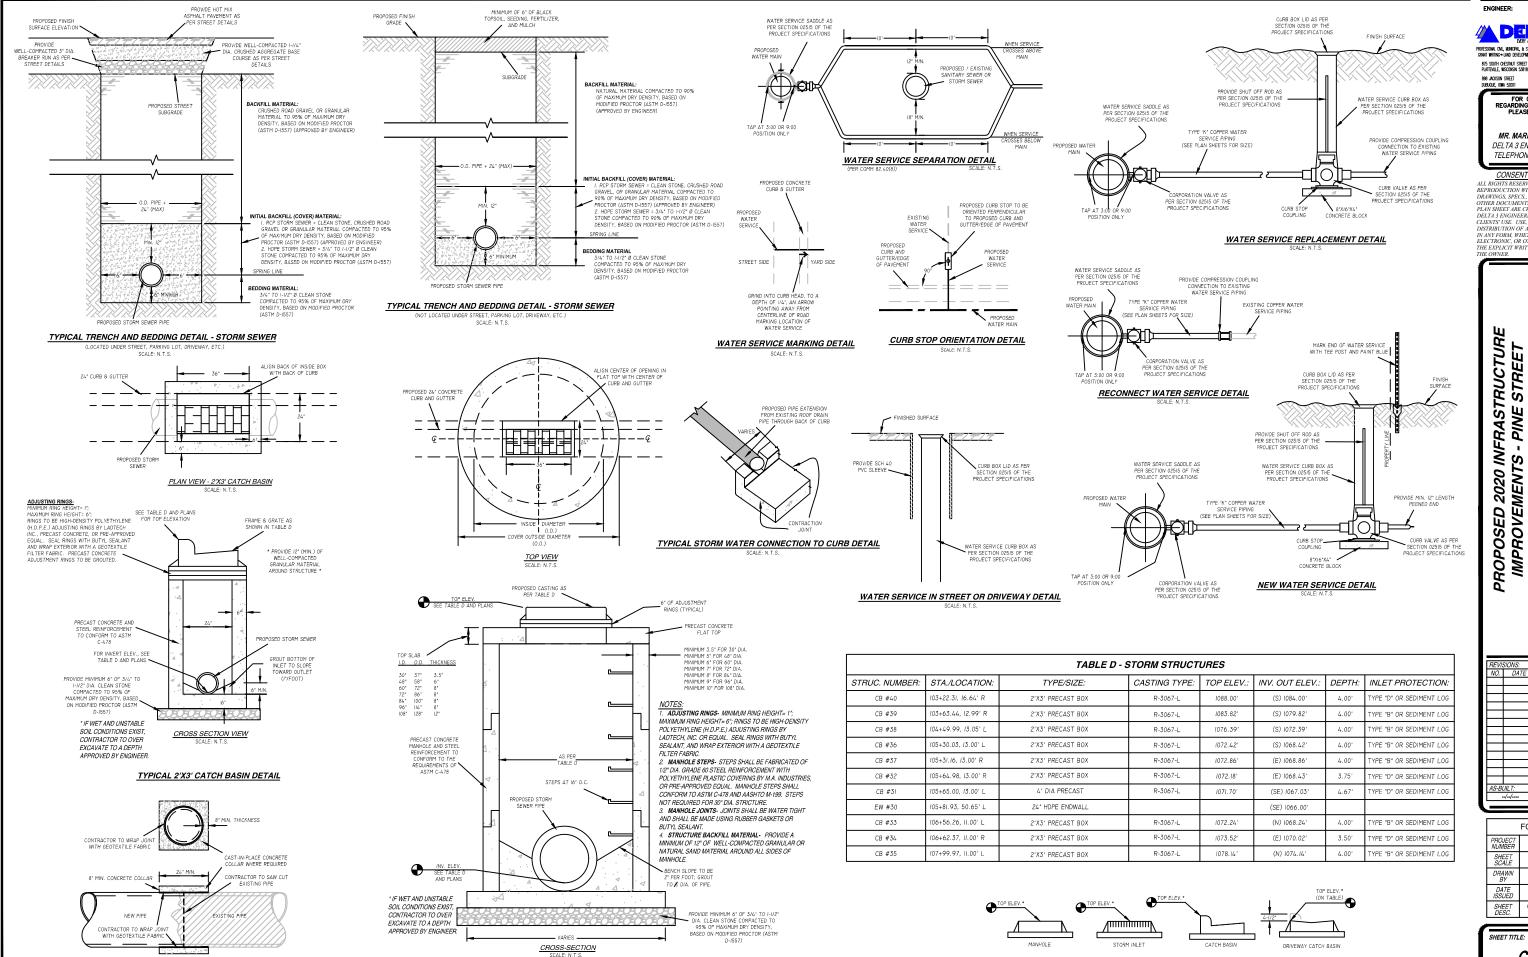

TYPICAL STORM STRUCTURE DETAIL

TYPICAL CONCRETE COLLAR DETAIL

DELTA 3 PROFESSIONAL CIVIL, MUNICIPAL, & STRUCTURAL ENGINEERING A-RICHTECTL GRANT WRITING A LAND DEVELOPMENT A PLANNING & CADD SERVICES 875 SOUTH CHESTNUT STREET PHONE: (608) 348-5355 PLATTEVILLE, WISCONSIN 53818

898 JACKSON STREET

FOR QUESTIONS REGARDING THIS PROJECT, PLEASE CONTACT:

PHONE: (563) 542-9005

MR. MARK DIGMAN, P.E. DELTA 3 ENGINEERING INC. TELEPHONE: (608) 348-5355

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T- WASH MINERAL POINT, I CATION: PINE STREET (W. COMMERCE ST NERLE POINT; 137 HIGH STREET, SUITE 1,

D20-001 NOT TO SCALE C. COYIER APRIL 27, 2020 DETAILS - WATER of STORM SYSTEMS

SHEET TITLE:


C205

NUMBER # 11 of 15

## REPLACE WITH 4" OF

#### TYPICAL CONCRETE SIDEWALK TIE-IN TO STEPS DETAIL

SCALE: N.T.S.

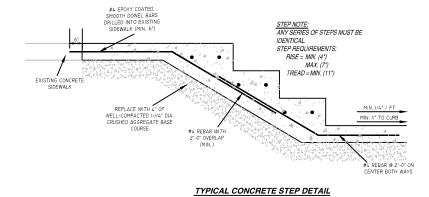

## EXISTING CONCRETE DRIVEWAY PROVIDE AND INSTALL 1/2" EPOXY-COATED DOWEL BARS AT 2'-0"

GENERAL NOTES- STREET: 1. ALL AREA DISTURBED DURING CONSTRUCTION THAT IS NOT TO BE PAVED SHALL BE RESTORED WITH A MINIMUM 6" OF TOPSOIL FERTILIZER, SEED, AND MULCH UNLESS OTHERWISE SPECIFIED.

2. CONTRACTOR WILL BE RESPONSIBLE FOR REPLACEMENT OF ALL DISTURBED PROJECT AREA COMPONENTS INCLUDING, BUT NOT LIMITED TO, EXISTING CONCRETE, BITUMINOUS PAVEMENT,

NOTED FOR REMOVAL.

GRAVEL, CULVERTS, WATER AND SANITARY SEWER COMPONENTS. STORM SEWER SYSTEM COMPONENTS, MAILBOXES, LAWN ORNAMENTS, AND LANDSCAPING THAT ARE NOT SPECIFICALLY

GENERAL NOTES - CONCRETE DRIVEWAY:

1. ALL JOINTS SHALL BE HAND TOOLED; NO SAWCUTTING WILL BE


PERMITTED.

SCORE ALL NEW CONCRETE TO MATCH ADJACENT WORK. PROVIDE #4 EPOXY-COATED. SMOOTH DOWEL BARS BETWEEN


NEW AND EXISTING CONCRETE DRIVEWAY.

4. PROVIDE LIGHT BROOM FINISH.


TYPICAL CONCRETE DRIVEWAY DETAIL

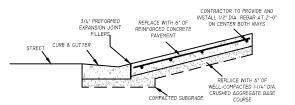


#### TYPICAL CONCRETE DRIVEWAY DETAIL (ALONG CURB AND GUTTER)

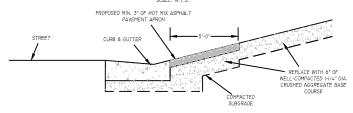

#### TYPICAL GRAVEL DRIVEWAY ALONG CURB & GUTTER DETAIL

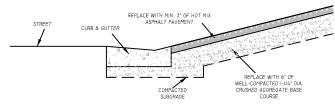


### TYPICAL HOT MIX ASPHALT PAVEMENT DRIVEWAY - RESIDENTIAL DETAIL

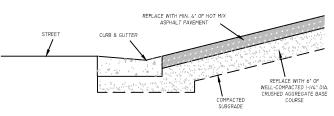


#### TYPICAL HMA PAVEMENT DRIVEWAY - COMMERCIAL DETAIL

PROPOSED PAVEMENT


#### STANDARD 30" CURB & GUTTER

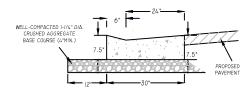


#### STANDARD 30" ROLL- BACK CURB AND GUTTER

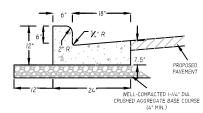


#### STANDARD 24" CURB & GUTTER DETAIL

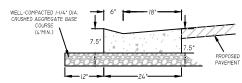


#### STANDARD 24" ROLL- BACK CURB AND GUTTER DETAIL

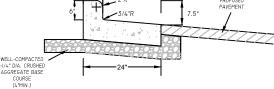


#### STANDARD 24" REVERSE-PITCH CURB & GUTTER DETAIL

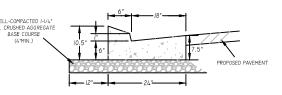


#### 24" TYPE 'X' CURB AND GUTTER DETAIL

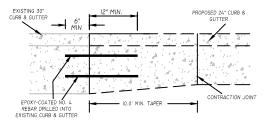

## 24" CURB & GUTTER MATCH TO 30" CURB & GUTTER DETAIL

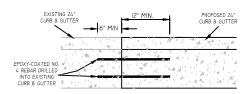

#### 24" CURB & GUTTER MATCH DETAIL

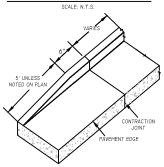

#### END SECTION-CURB & GUTTER TAPER DETAIL

ENGINEER:

A DELTA 3

875 SOUTH CHESTINUT STREET PHONE: (608) 348-5365 PLATTEVILLE, WISCONSIN 53818 898 JACKSON STREET PHONE: (563) 542-9005 DUBUQUE, IONA 52001

FOR QUESTIONS REGARDING THIS PROJECT, PLEASE CONTACT:

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TELEPHONE: (608) 348-5355

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PROPOSED 2020 INFRASTRUCTUR IMPROVEMENTS - PINE STREET

\_ **PO/NT, W/**st (W. COMMERCE ST- WASHINGTON ST
GH STREET, SUITE 1, MINERAL POINT, W

FOR BID PROJECT NUMBER D20-001 SHEET SCALE NOT TO SCALE DRAWN BY C. COYIER DATE ISSUED APRIL 27, 2020 DETAILS - STORM SHEET DESC.

SEWER & STREET

SHEET TITLE:

AS-BUILT:

C206

NUMBER # 12 of 15

MINERAL POINT, WI LOCATION: PINE STREET (W. COMMERCE ST. WASHIN MINERAL POINT; 137 HIGH STREET, SUITE 1, MINERAL





875 SOUTH CHESTNUT STREET PHONE: (608) 348-5355 PLATTEVILLE, WISCONSIN 53818 898 JACKSON STREET PHONE: (563) 542–9005 DUBUQUE, 10MA 52001

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-CURB RAMP DETECTABLE WARNING FIELD MATERIALS AND DEVICES SHALL BE APPROVED BY THE ENGINEER. THE COLOR OF THE DETECTABLE WARNING FIELD

-SURFACE TEXTURE OF THE RAMP SHALL BE OBTAINED BY COURSE BROOMING

-DETECTABLE WARNING FIELDS FOR BIKE PATHS SHALL BE 6' WIDE FOR A 10' WIDE

1 THIS POINT IS AN EXTENSION OF OUTSIDE EDGE OF APPROACHING SIDEWALK WHERE IT MEETS THE BACK OF CONCRETE CURB.

(2) WHEN THIS DISTANCE IS LESS THAT 6'-0" IT MAY BE DIFFICULT TO ACHIEVE A 12H: 1V SLOPE, OR FLATTER, ON THE RAMP, REDUCE CURB HEIGHT IN TRIANGLE AREA TO ACHIEVE 12H:1V SLOPE, OR FLATTER, ON RAMP. 2' MINIMUM CURB HEIGHT.

## GENERAL NOTES - HANDICAP RAMPS:

-DETAILS OF CONSTRUCTION, MATERIALS AND WORKMANSHIP NOT SHOWN ON THIS DRAWING SHALL CONFORM TO THE PERTINENT REQUIREMENTS OF THE WISCONSIN DEPARTMENT OF TRANSPORTATION STANDARD SPECIFICATIONS (MOST CURRENT EDITION) AND THE APPLICABLE SPECIAL PROVISIONS.

RAMPS SHALL BE BUILT AT 12H:1V OR FLATTER. WHEN NECESSARY, THE SIDEWALK ELEVATION MAY BE LOWERED TO MEET THE HIGH POINT ON THE RAMP.


-THE DETECTABLE WARNING FIELD SHALL BE PAID FOR BY EACH 2'X4' (8 S.F.) OR 2'X2' (4 S.F.) INSTALLATION.

SHALL BE NO COLOR AND IS INCIDENTAL TO THE BID ITEM OF "CURB RAMP

-DETECTABLE WARNING FIELDS THAT ARE INSTALLED AS A GROUP OR SIDE BY SIDE, SHALL BE FROM THE SAME MANUFACTURER.

TRANSVERSE TO THE SLOPE OF THE RAMP.

RAMP OPENING AND 8' WIDE FOR A 12' WIDE OPENING. DETECTABLE WARNING FIELDS SHALL BE CENTERED ON OPENING.

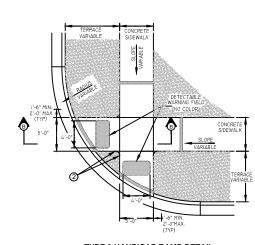

TYPE 2 HANDICAP RAMP DETAIL

SHEET TITLE: C207

AS-BUILT:

PROJECT NUMBER

SHEET SCALE

DRAWN BY

DATE ISSUED

SHEET DESC.

D20-001


NOT TO SCALE

C. COYIER


APRIL 27, 2020

DETAILS - ADA & STRE


SHEET NUMBER # 13 of 15

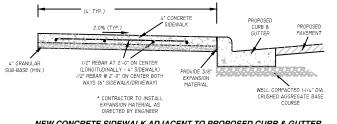


#### NEW CONCRETE SIDEWALK ADJACENT TO PROPOSED CURB & GUTTER

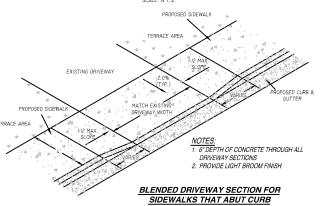

## PROPOSED DETECTABLE WARNING FIELD (NO COLOR) <u>LEGEND</u> NORMAL SIDEWALK CONTRACTION JOINT- FIELD LOCATED PAVEMENT MARKING, WHITE, 6- INCH CROSS-SECTION A - HANDICAP RAMP DETAIL

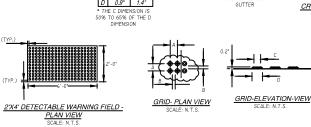

2'X2' DETECTABLE WARNING FIELD -PLAN VIEW SCALE: N.T.S.

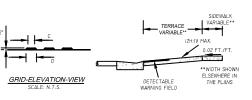

CROSS SECTION B - HANDICAP RAMP DETAIL
SCALE: N.T.S. SCALE: N.T.S.

NOTES SIDEWALK:

1. ALL JOINTS SHALL BE HAND TOOLED; NO SAW CUTTING WILL BE PERMITTED.

2. SCORE ALL NEW CONCRETE TO MATCH ADJACENT WORK.

3. PROVIDE #4 EPOXY-COATED, SMOOTH DOWEL BARS BETWEEN NEW AND EXISTING CONCRETE SIDEWALK.

4. PROVIDE LIGHT BROOM FINISH.


AND INSTALL #4 EPOX

TYPICAL SIDEWALK CONNECTION DETAIL

4'-0" TYPICAL

TYPICAL CONCRETE SIDEWALK DETAIL

TYPE 1A HANDICAP RAMP DETAIL (CENTER OF CORNER RADIUS)

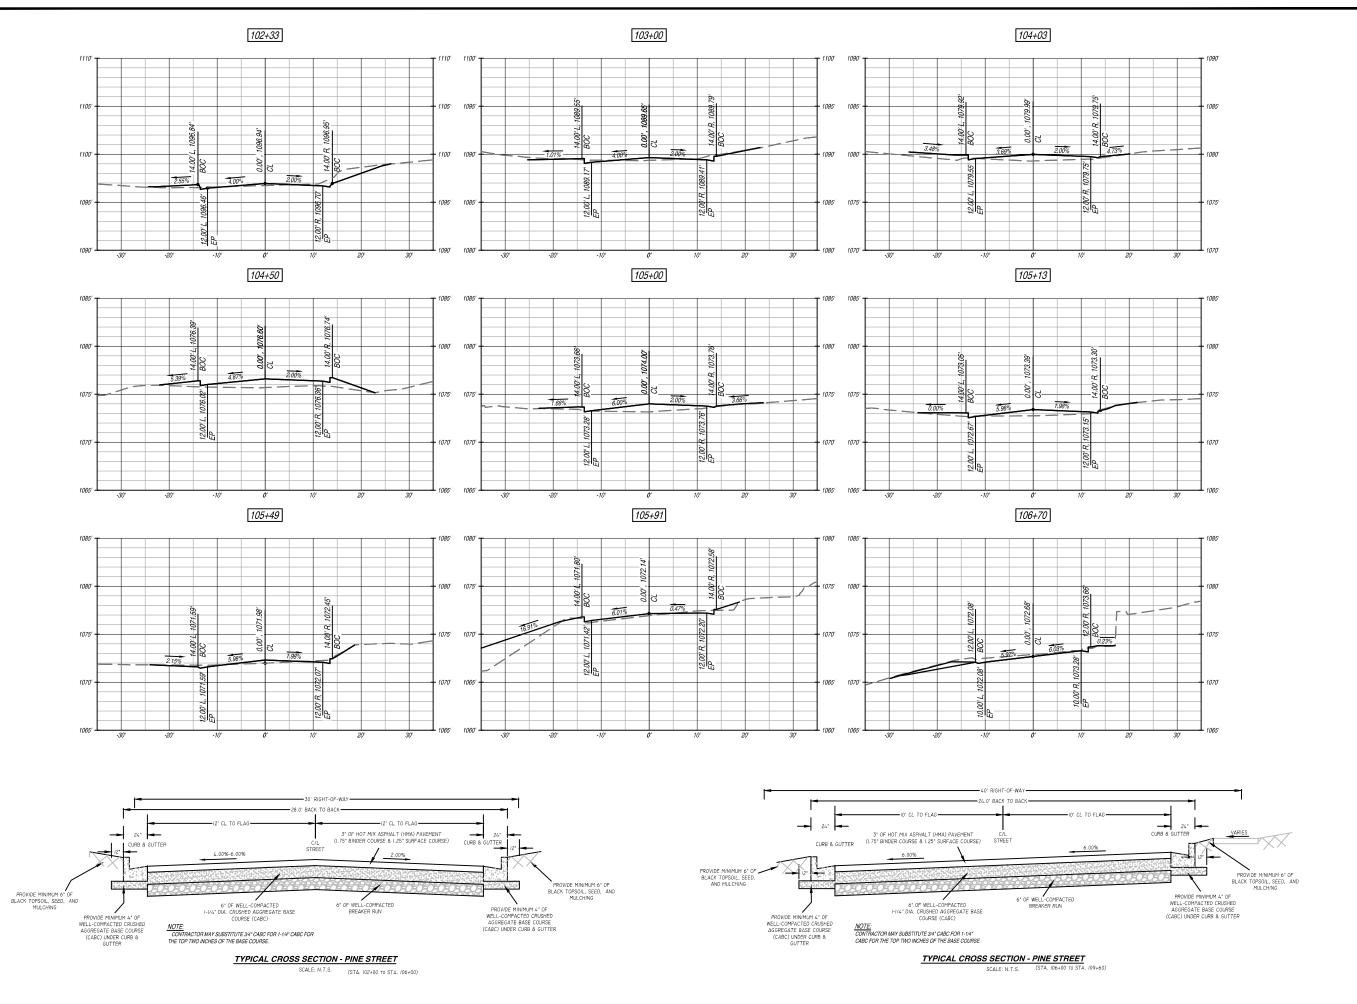

ENGINEER:

DELTA 3

Professional Civil, Munopal, & Structural Engineering-Architect Grant Writing-Land Development-Planning & CADD Services

875 SOUTH CHESTNUT STREET PHONE: (608) 348-5355 PLATTEVILLE, WISCONSIN 53818 898 JACKSON STREET PHONE: (563) 542–9005 DUBUQUE, KOWA 52001

FOR QUESTIONS REGARDING THIS PROJECT, PLEASE CONTACT:

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PROPOSED 2020 INFRASTRUCTURI IMPROVEMENTS - PINE STREET

MINERAL POINT, WI
LOCATION: PINE STREET (W. COMMERCE ST. WASHINGTON ST)
MINERAL POINT; 137 HIGH STREET, SUITE 1, MINERAL POINT, W


FOR BID PROJECT NUMBER D20-001 HORZ.-1"=10' VERT.-1"=5' SHEET SCALE DRAWN BY C.COYIER DATE ISSUED APRIL 27, 2020 CROSS-SECTIONS PINE STREET SHEET DESC.

SHEET TITLE:

AS-BUILT:

C301

SHEET NUMBER # 14 of 15

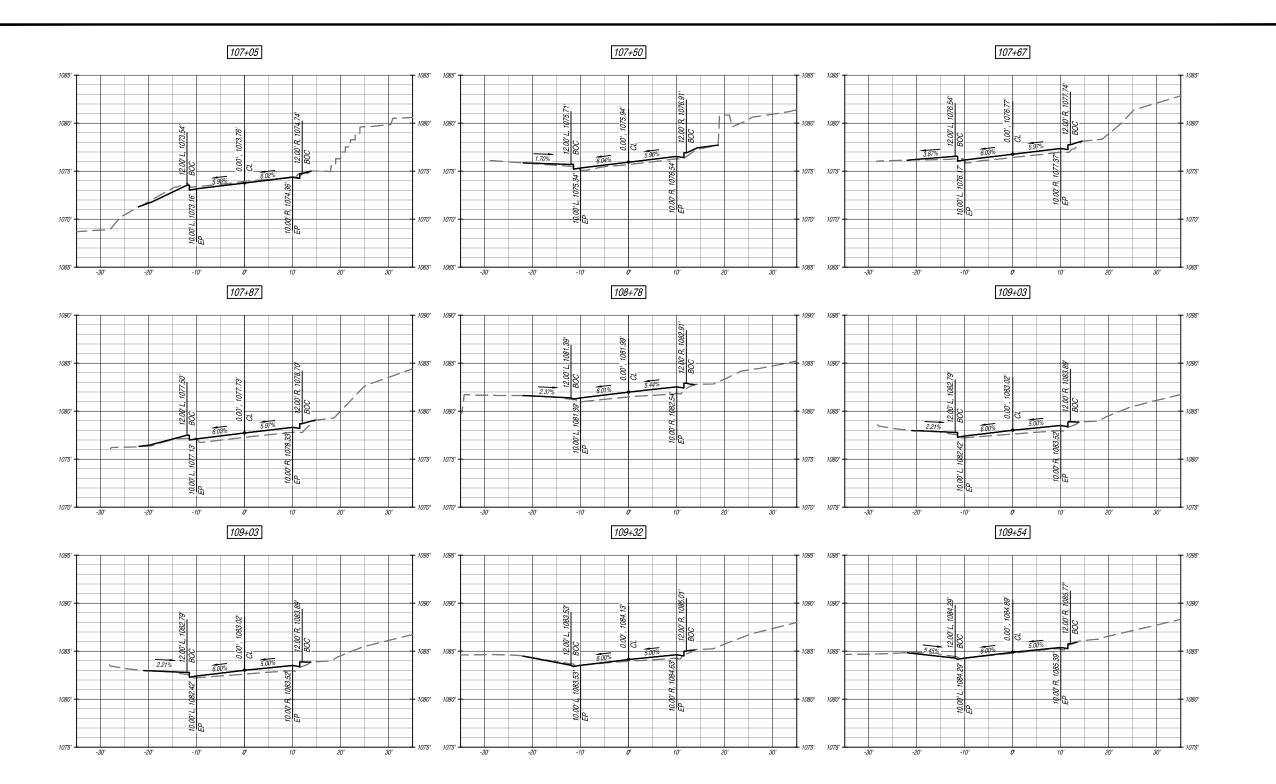

ENGINEER:



DELL'TA 3

PRESSONA, ONI, MAIORI, & STRICTION, DEMERNE-ARCHECHE
GRANT HRITING-LAGO DEVELOPMENT-PLANNIC & CADO SERVICES 8875 SOUTH CHESTINUT STREET PHONE: (608) 348-5355
PLATECULE, WISCONSIN 53518
888 JACKSON STREET PHONE: (563) 542-9005
DUBLOUE, KOMA 52001

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PROPOSED 2020 INFRASTRUCTURE IMPROVEMENTS - PINE STREET

MINERAL POINT, WI
LOCATION: PINE STREET (W. COMMERCE ST- WASHINGTON ST)
MINERAL POINT; 137 HIGH STREET, SUITE 1, MINERAL POINT, WI

REVIS	SIONS:	
NO.	DATE	DESCRIPTION
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AS-BL	JILT:	BY:
	-//	-,

FOR BID				
PROJECT NUMBER	D20-001			
SHEET SCALE	HORZ1" =10' VERT1" =5'			
DRAWN BY	C.COYIER			
DATE ISSUED	APRIL 27, 2020			
SHEET DESC.	CROSS-SECTIONS - PINE STREET			

SHEET TITLE:

C302

SHEET NUMBER # 15 of 15